THE HAWORTH

A 28-UNIT MULTI-FAMILY RESIDENTIAL DEVELOPMENT

TAX LOT 00800, MAP R3216CB NEWBERG, OR 97132

SITE INFORMATION

ADDRESS: NO ADDRE
1/4 SECTION MAP: R3216CB
TAX LOT: 00800

TOTAL SITE AREA: 0.82 AC ZONING: C-2 (COMMUNITY COMMERCIAL)

VERTICAL DATUM

BASIS OF BEARING:

ELEVATIONS ARE BASED ON GEODETIC CONTROL POINT STATION NO. 22, A BRASS DISC ON 1" IP IN MONUMENT CASE. DISC IS 4" BELOW PAVEMENT SURFACE. POINT IS THE NORTHEAST CORNER OF THE RICHARD EVEREST DONATION LAND CLAIM #52, ON THE WESTERLY LINE OF THE SEBASTIAN BRUTSCHER DONATION I AND CLAIM #51

DONATION LAND CLAIN

BASIS OF ELEVATION:

UTILITY COMPANIES

AATER
SEWER
- CITY OF NEWBERG
- NORTHWEST NATURAL
- PORTLAND GENERAL ELECTRIC
- FRONTIER
- COMCAST/FRONTIER

PROJECT CONTACTS

<u>APPLICANT</u>

GROVE DEVELOPMENT, INC.
7570 SW 74th AVENUE
PORTLAND, OR 97223
P: (503) 793-3299
E: grove@grovedevelopment.net
CONTACT: GROVE HUNT

PLANNING/ENGINEERING/SURVEYING

PIONEER DESIGN GROUP, INC.

PIONEER DESIGN GROUP, INC.

POSTURAND, OR 97223

POSTU

ARCHITECT
OLSON GROUP ARCHITECTS PC

17150 SW UPPER BOONES FERRY ROAD
DURHAM, OR 97224
P: (503) 620-9870
E: design@olsongrouparchitects.com
CONTACT: CURT OLSON

LANDSCAPE ARCHTECT


PIONEER DESIGN GROUP, INC.
9020 SW WASHINGTON SQ. RD., STE 170
PORTLAND, OR 97223
P: (503) 643-8286
E: bholmes@pd-grp.com
CONTACT: BEN HOLMES

<u>OWNER</u>

PATRICK R. AND ELAINE A. MAVEETY 4604 COOPERS HAWK ROAD KLAMATH FALLS, OR 97601

ATTENTION: Oregon law requires you to follow rules adopted by the Oregon Utility Notification Center. Those rules are set forth in OAR 952-001-0001 through 952-001-0090. You may obtain copies of the rules by calling the center.

NOTE: The telephone number for the Oregon Utility Notification Center is (503) 232-1987.

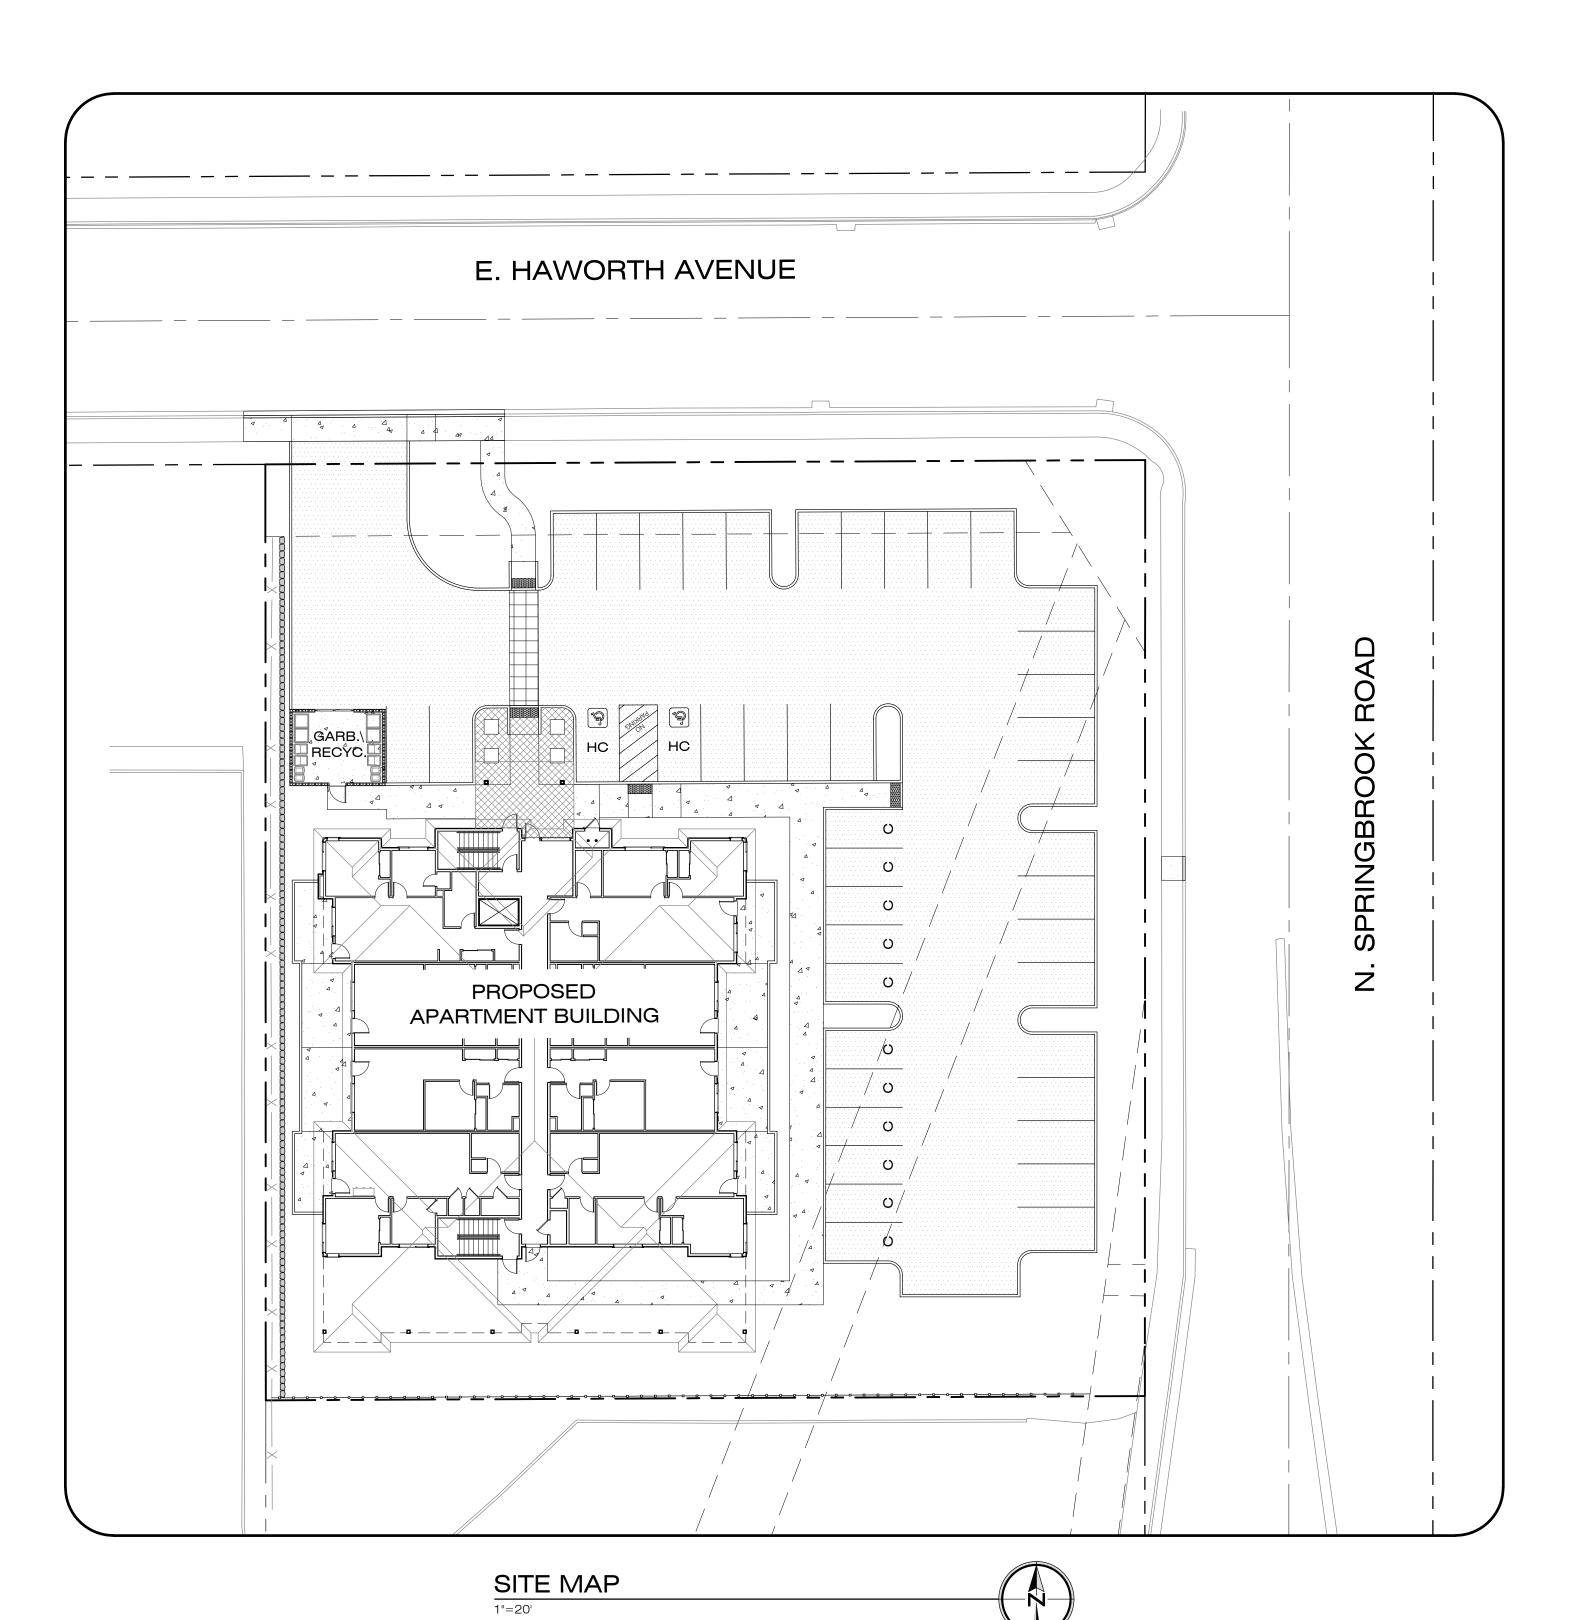






SHEET INDEX

SHEET NUMBER	SHEET DESCRIPTION
P1.0	COVER SHEET
P2.0	EXISTING CONDITIONS AND DEMOLITION PLAN
P3.0	PRELIMINARY GRADING AND EROSION CONTROL PLAN
P4.0	PRELIMINARY SITE PLAN
P5.0	PRELIMINARY COMPOSITE UTILITY PLAN
P6.0	AERIAL AND CIRCULATION PLAN (SITE ANALYSIS DIAGRAM)
L1.0 - L1.1	PRELIMINARY LANDSCAPE PLAN, LEGENDS, DETAILS & NOTES



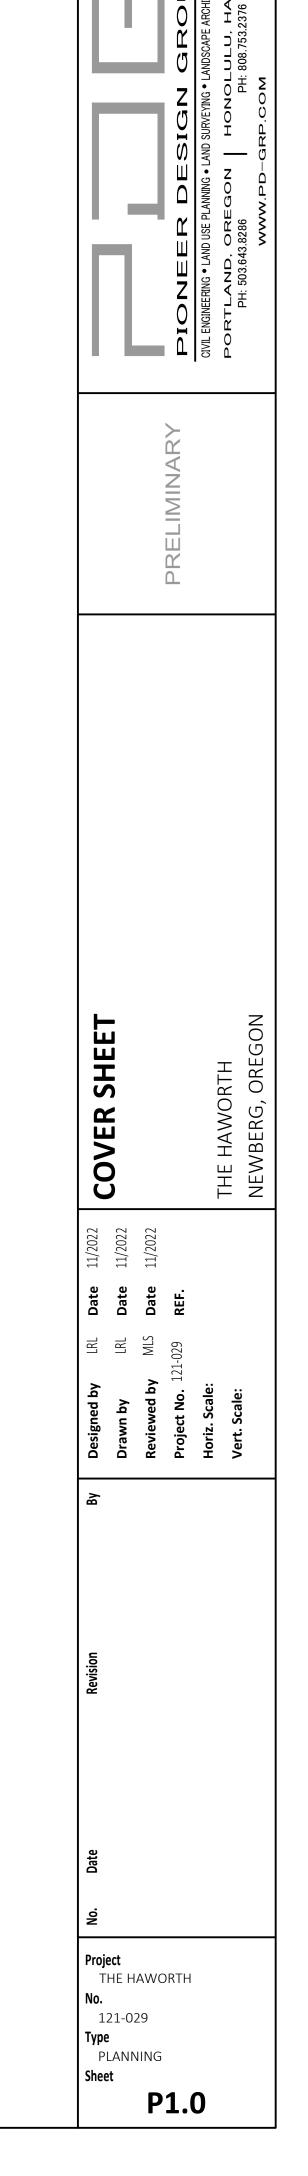

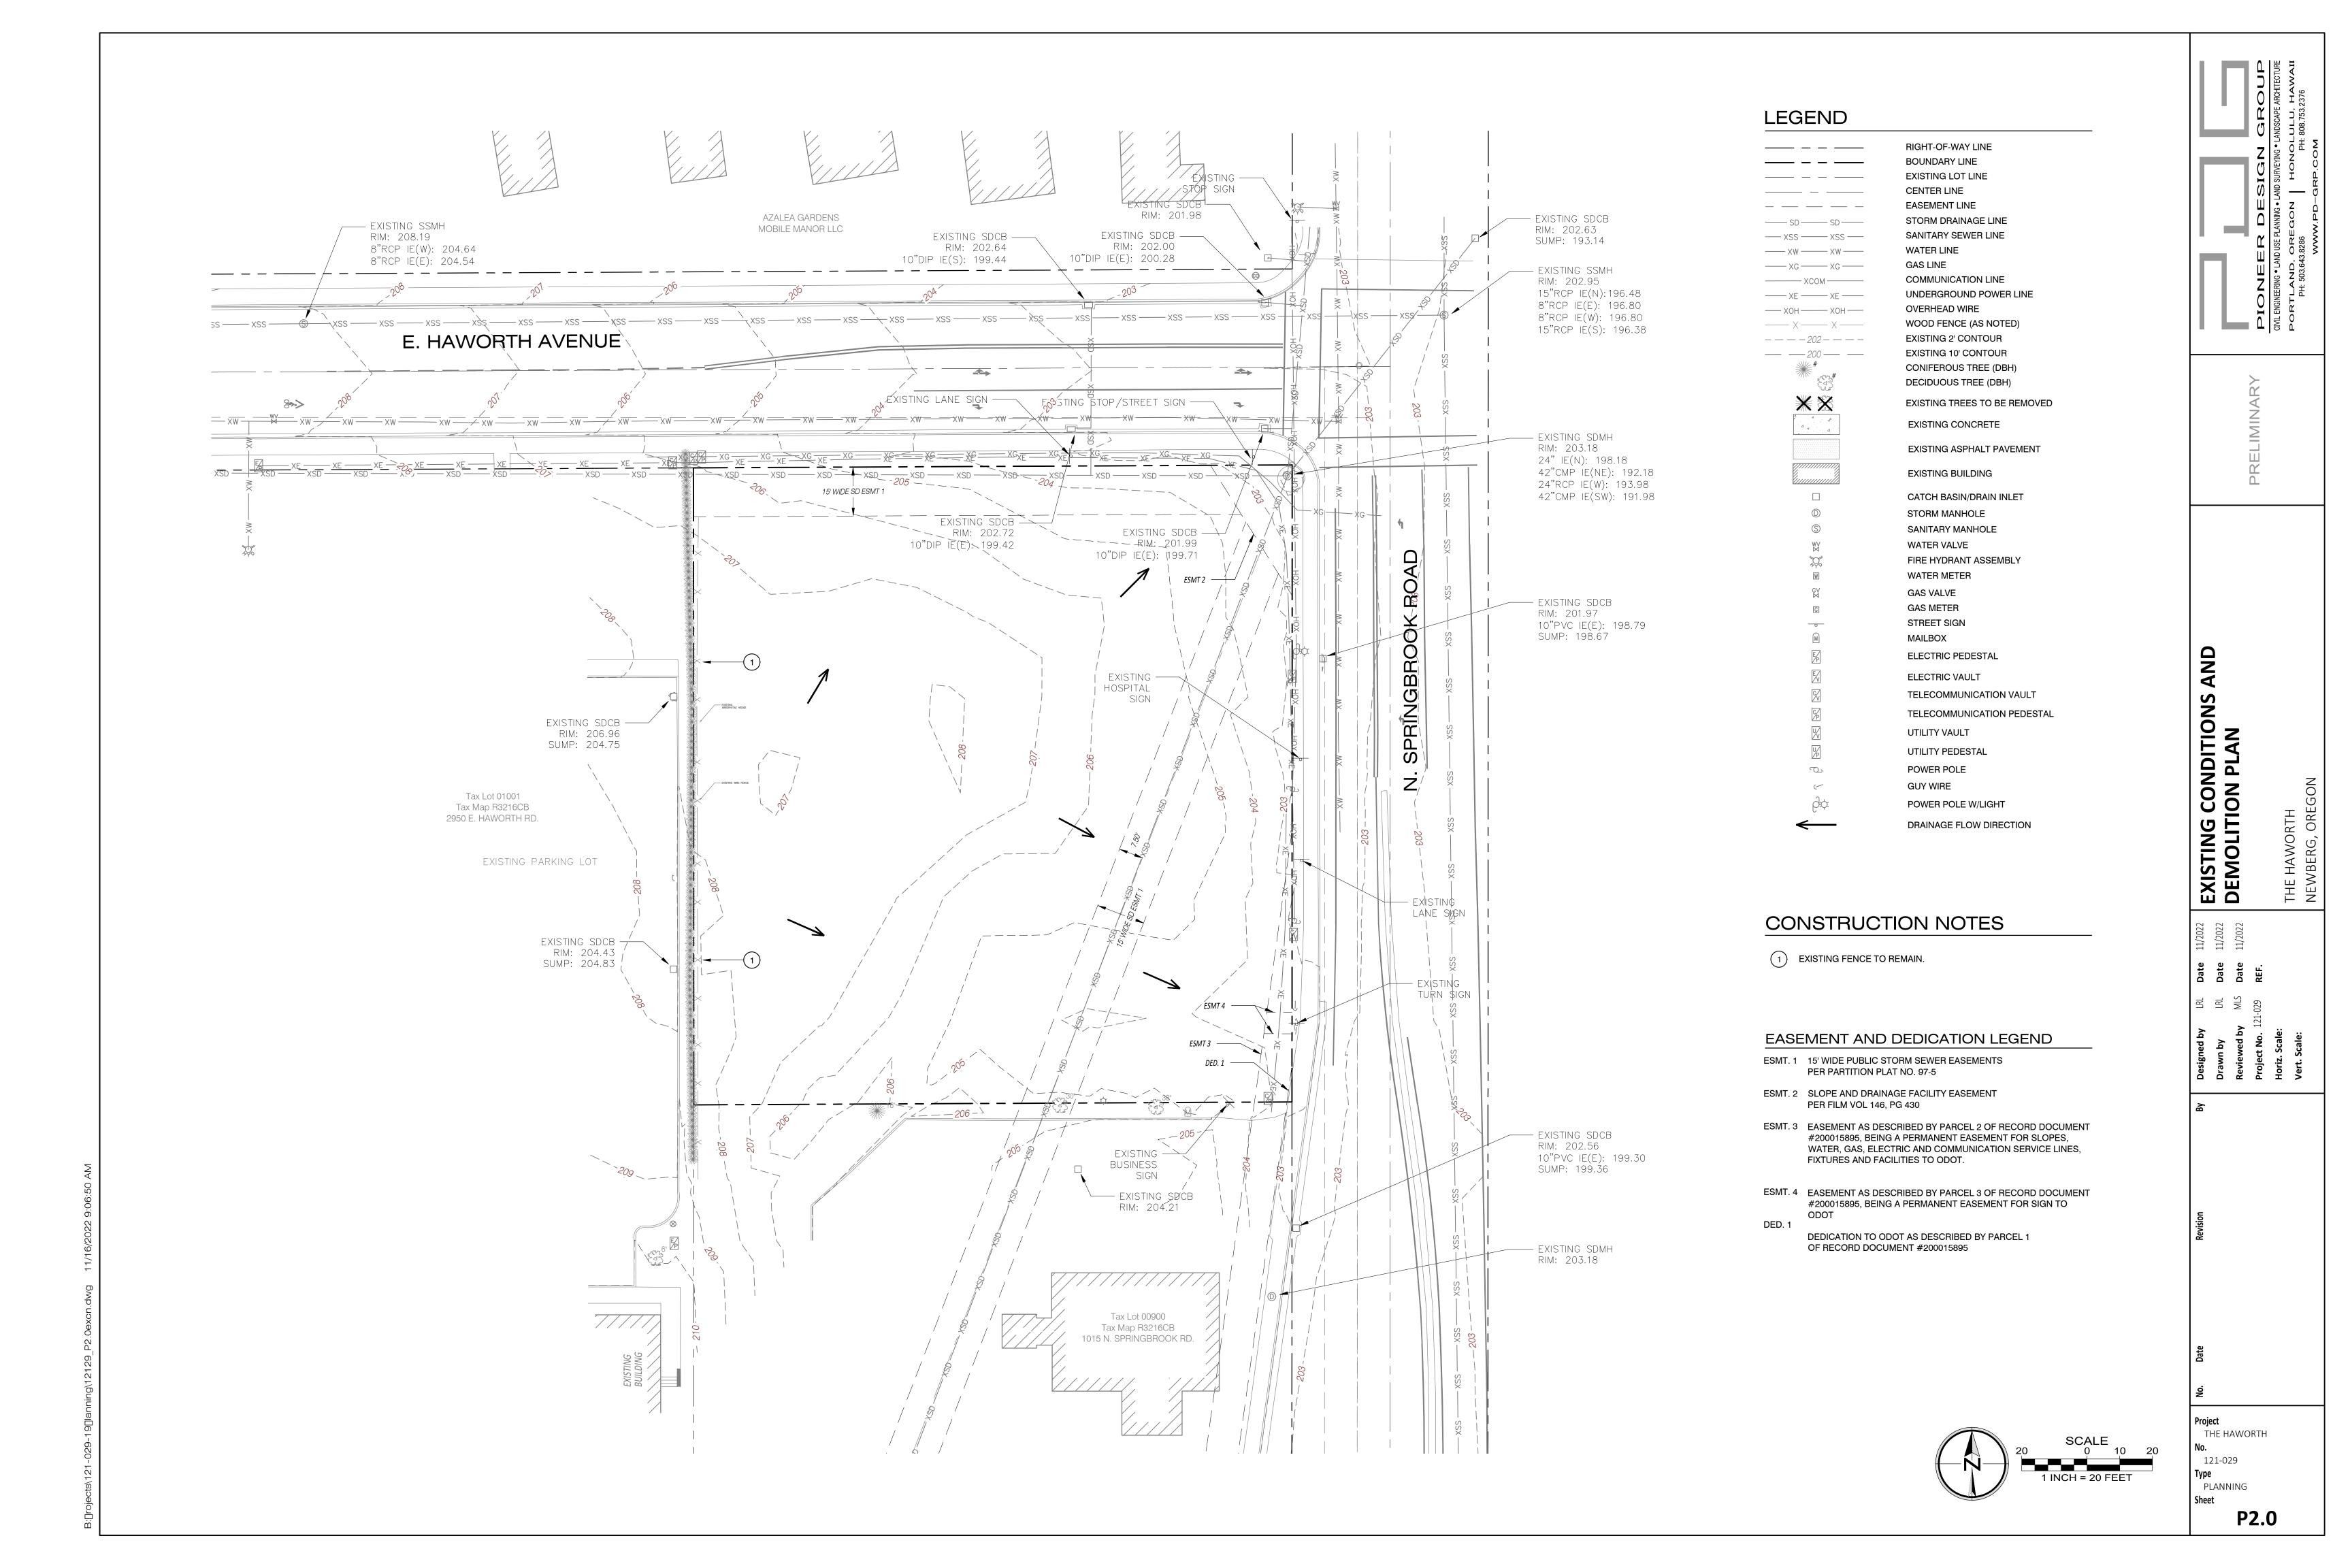

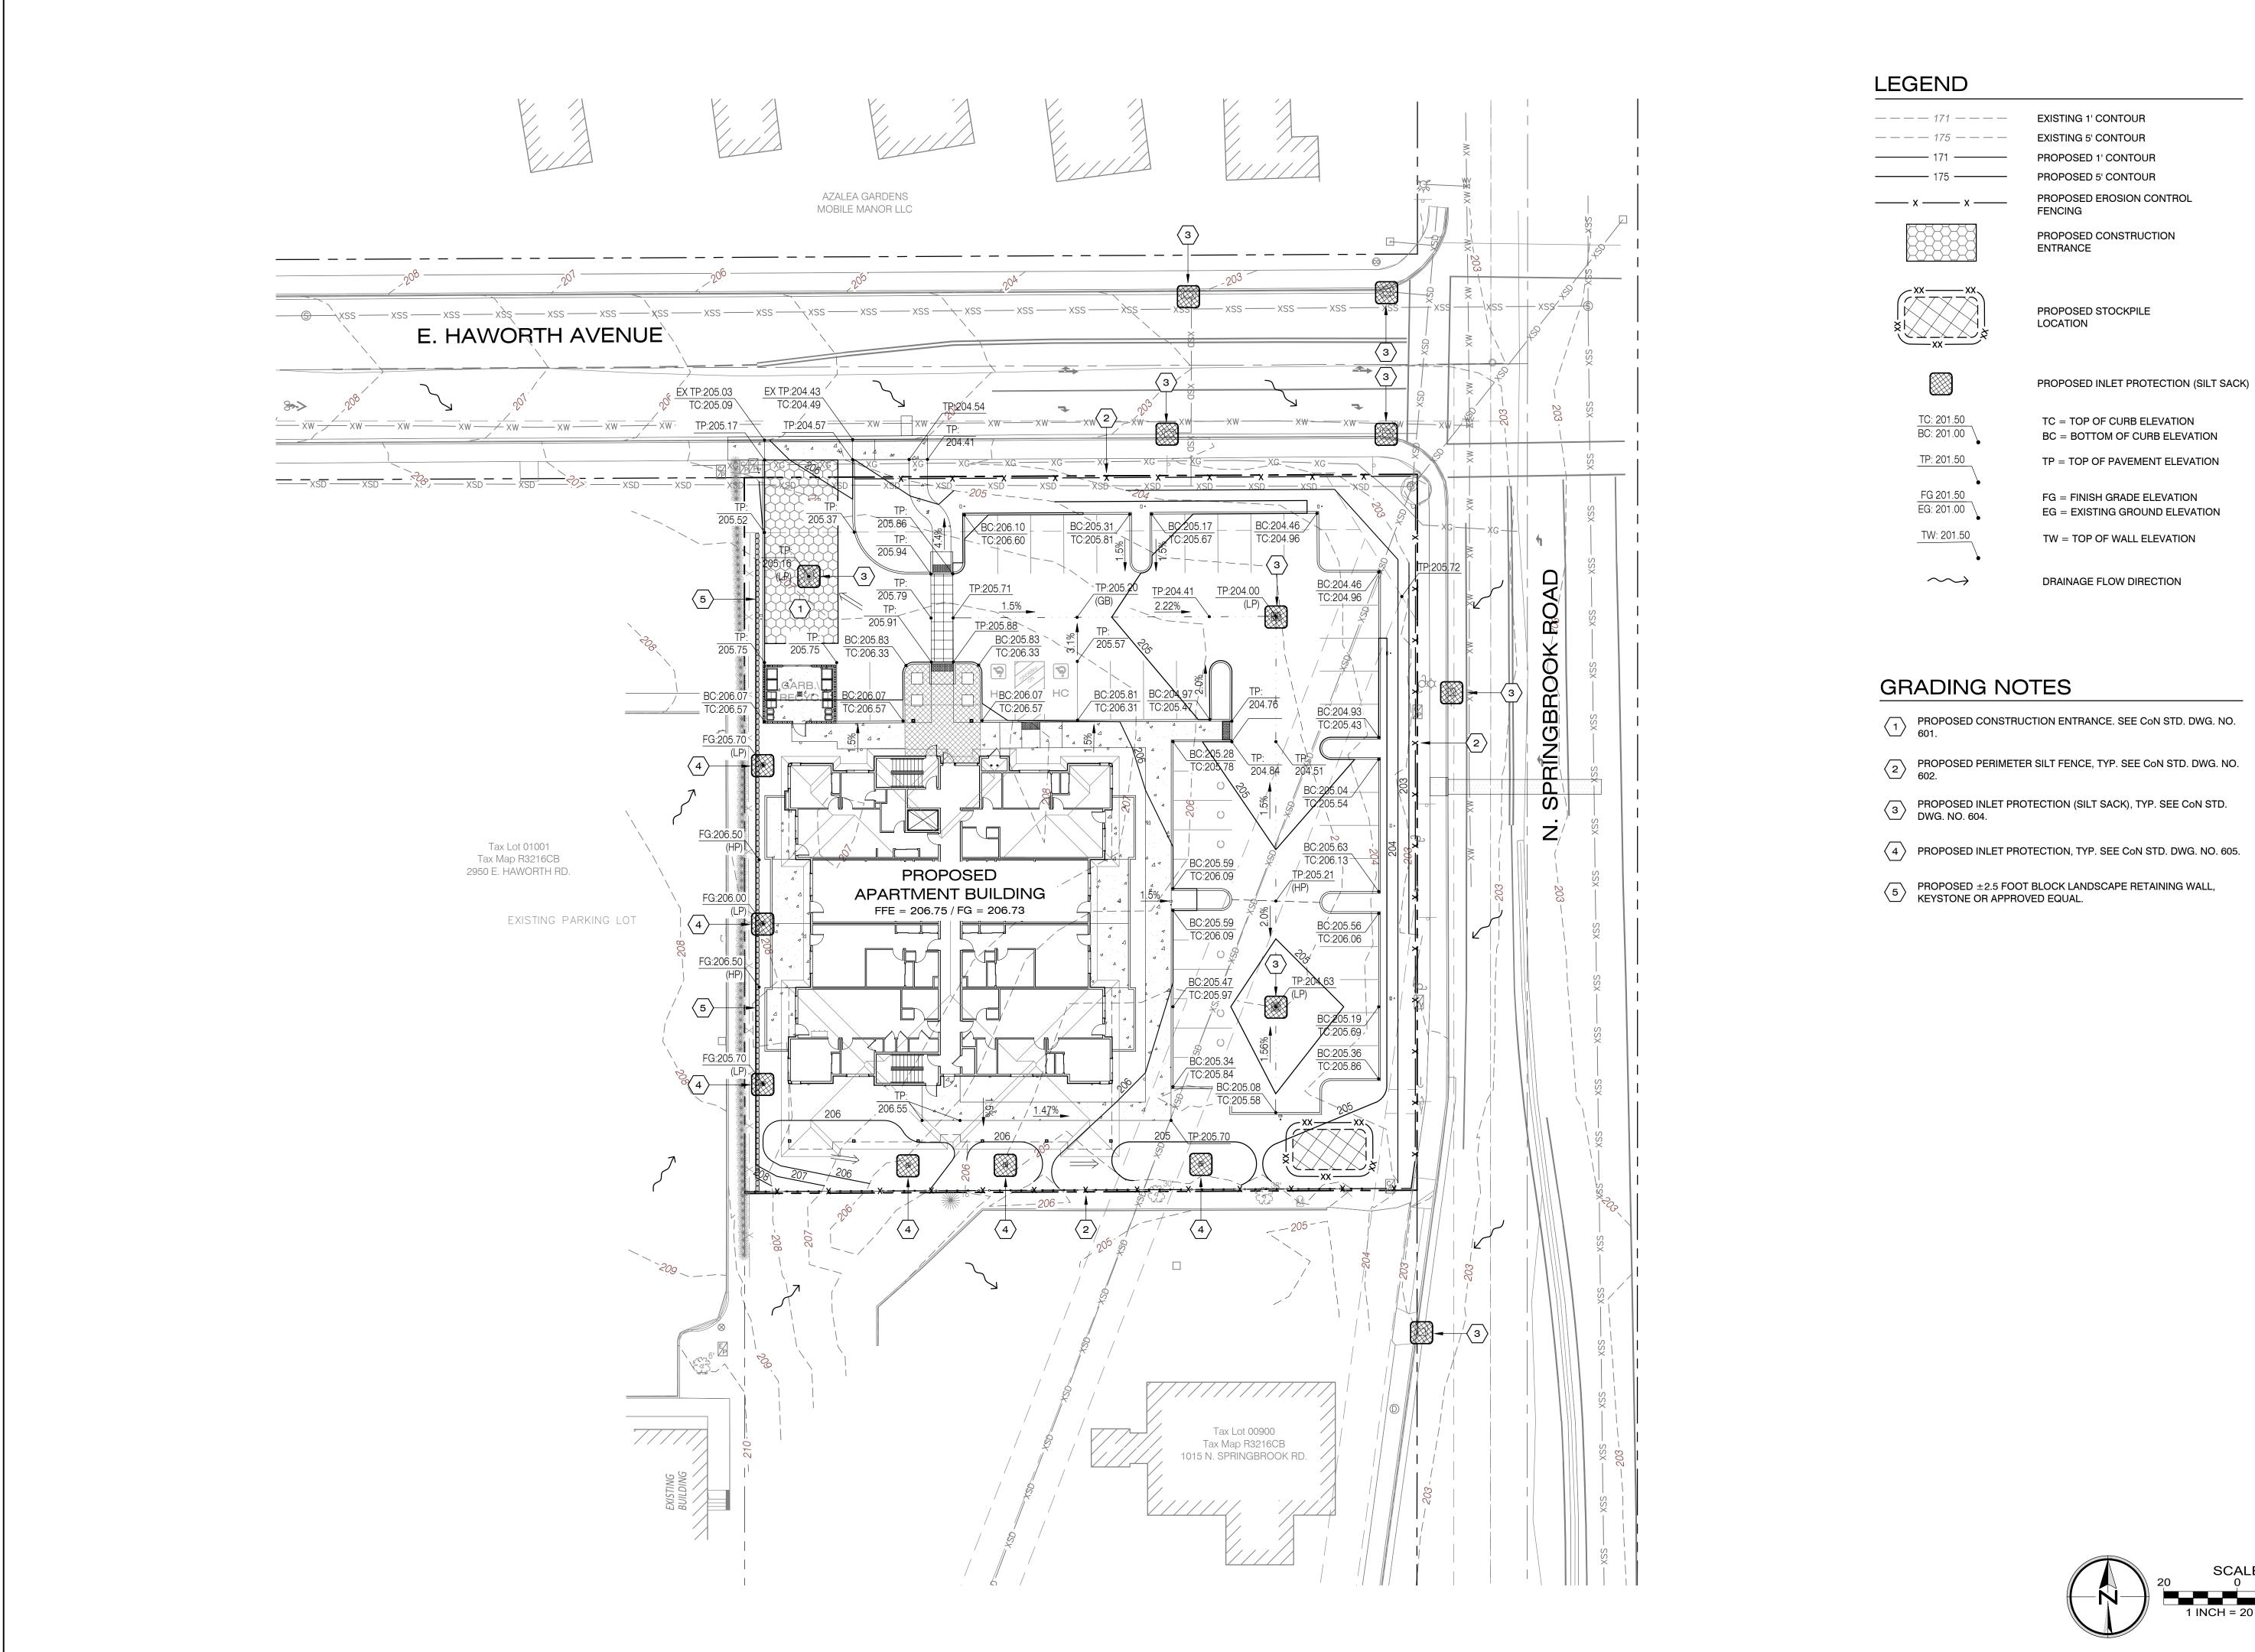


1 INCH = 20 FEET


ARY GRADING AND CONTROL PLAN PRELIMINA EROSION

THE HAWORTH 121-029

PLANNING

P3.0

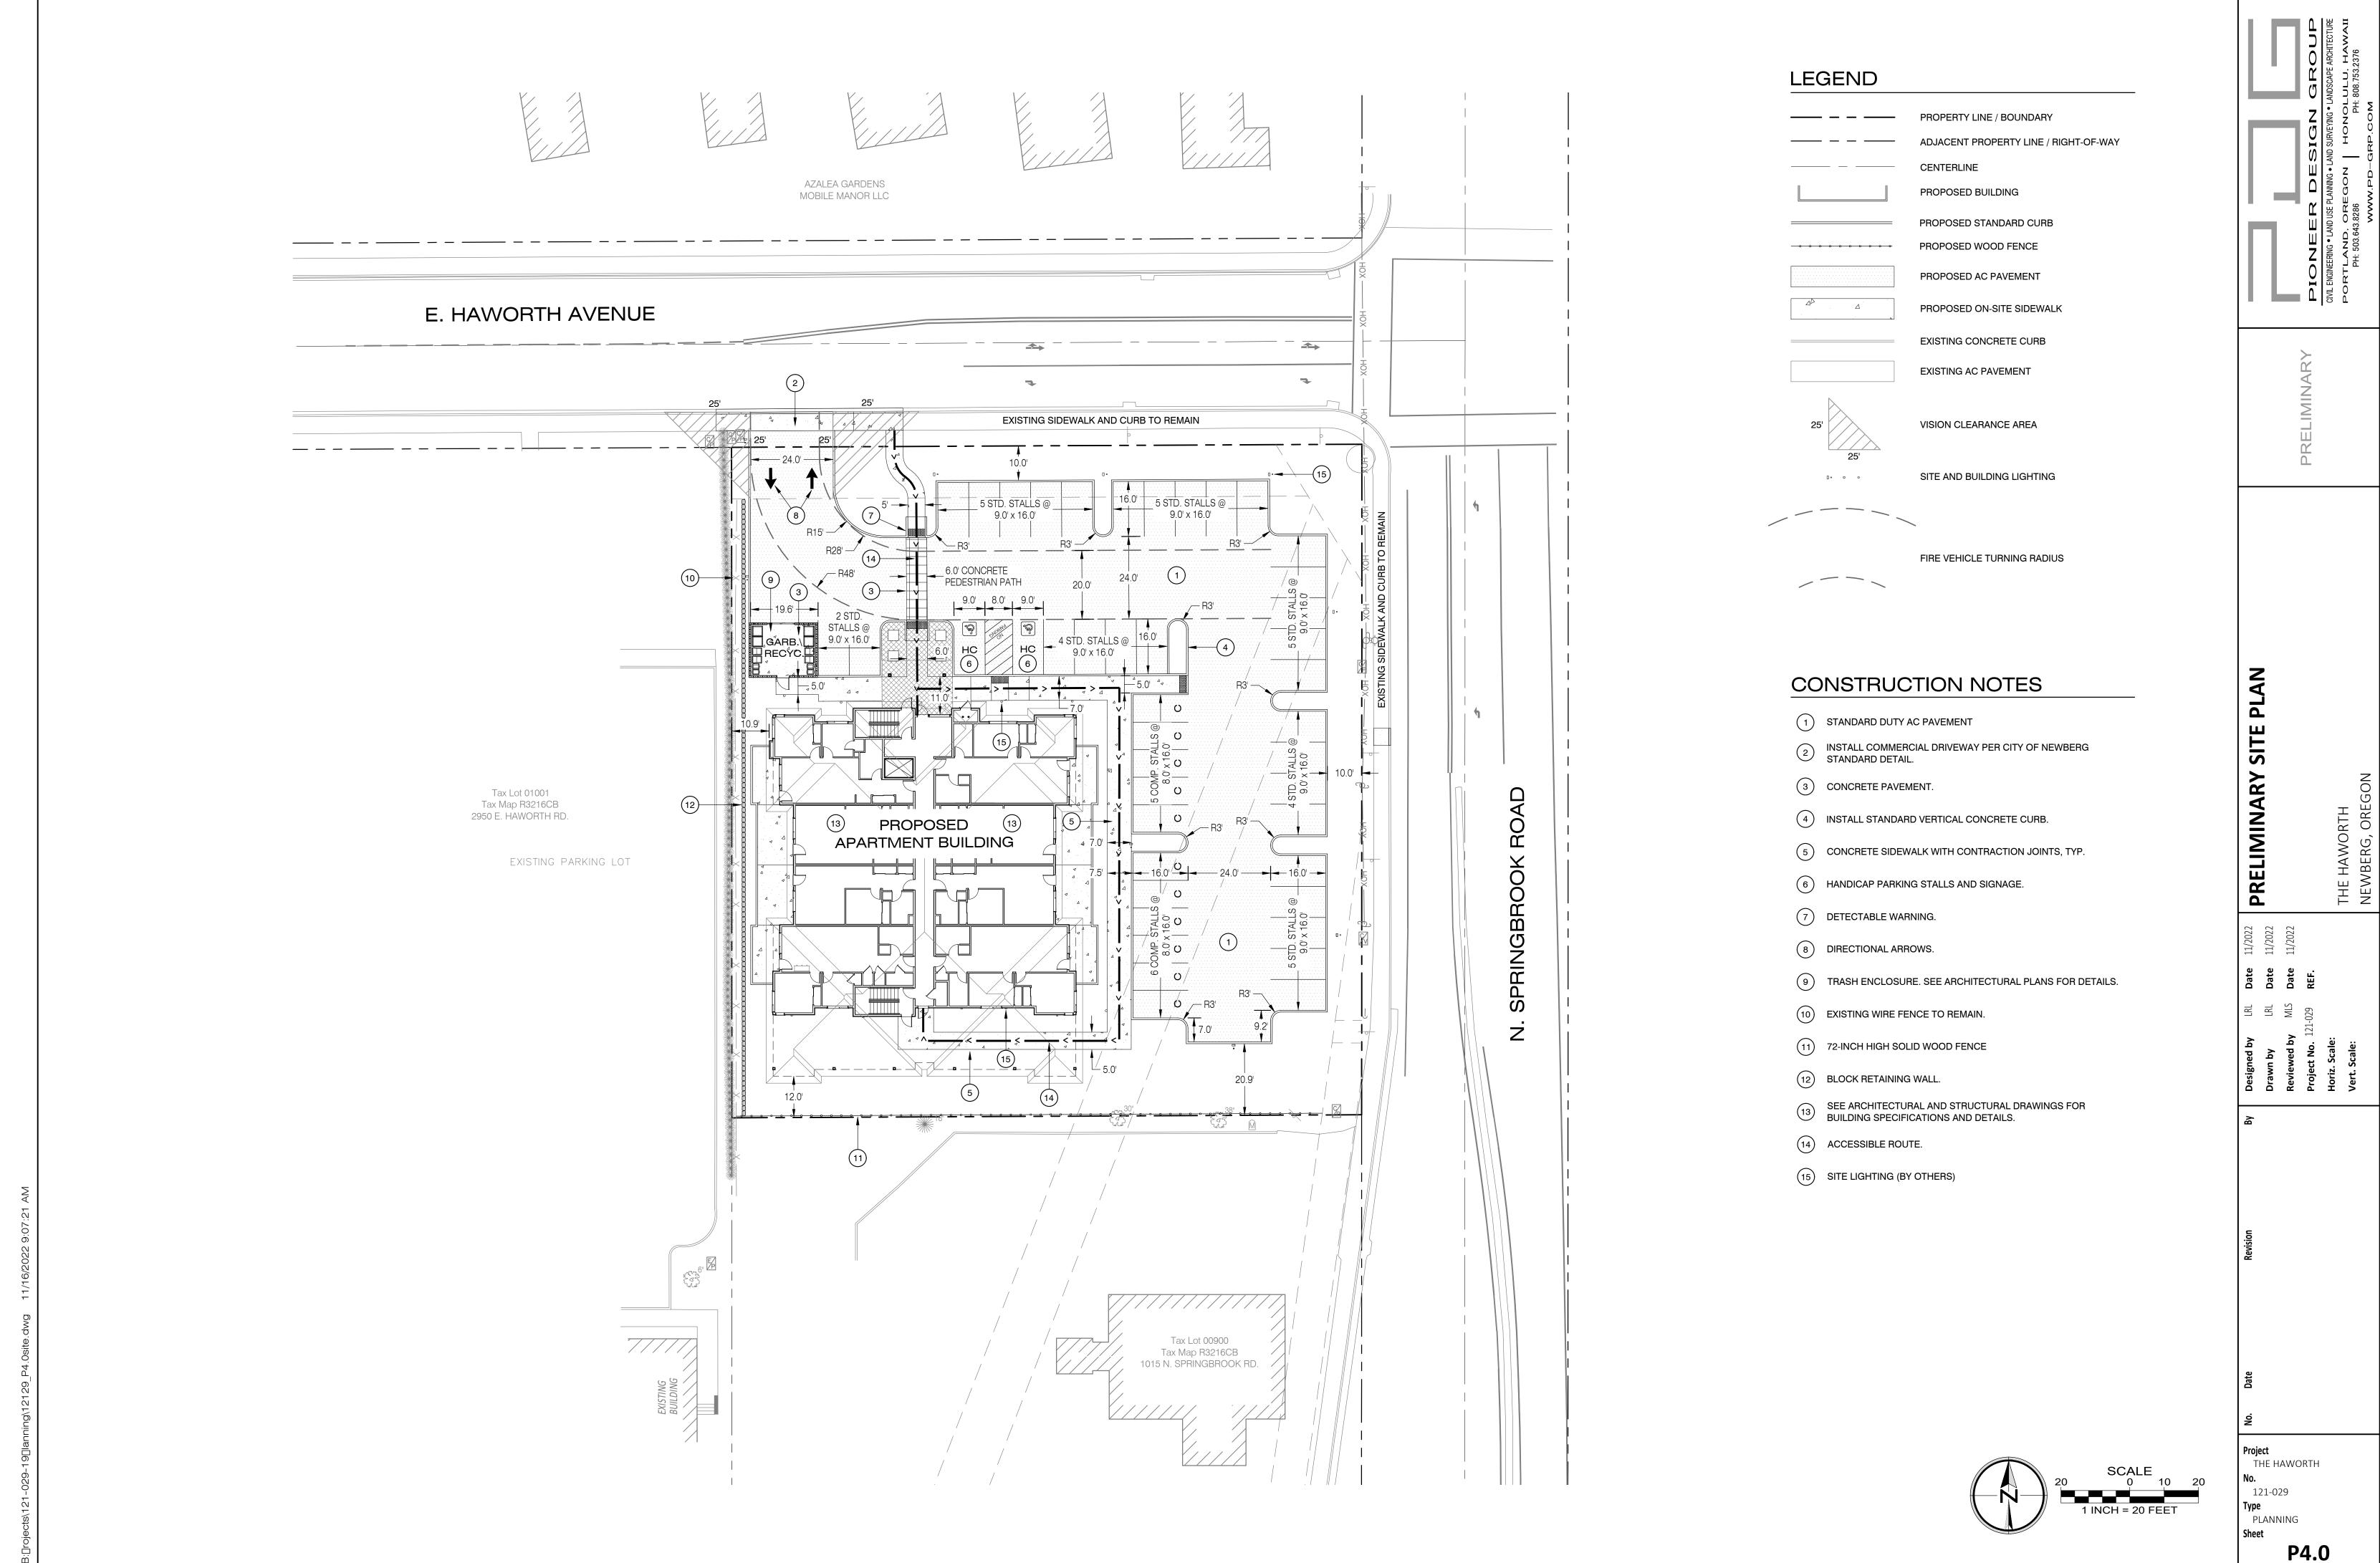

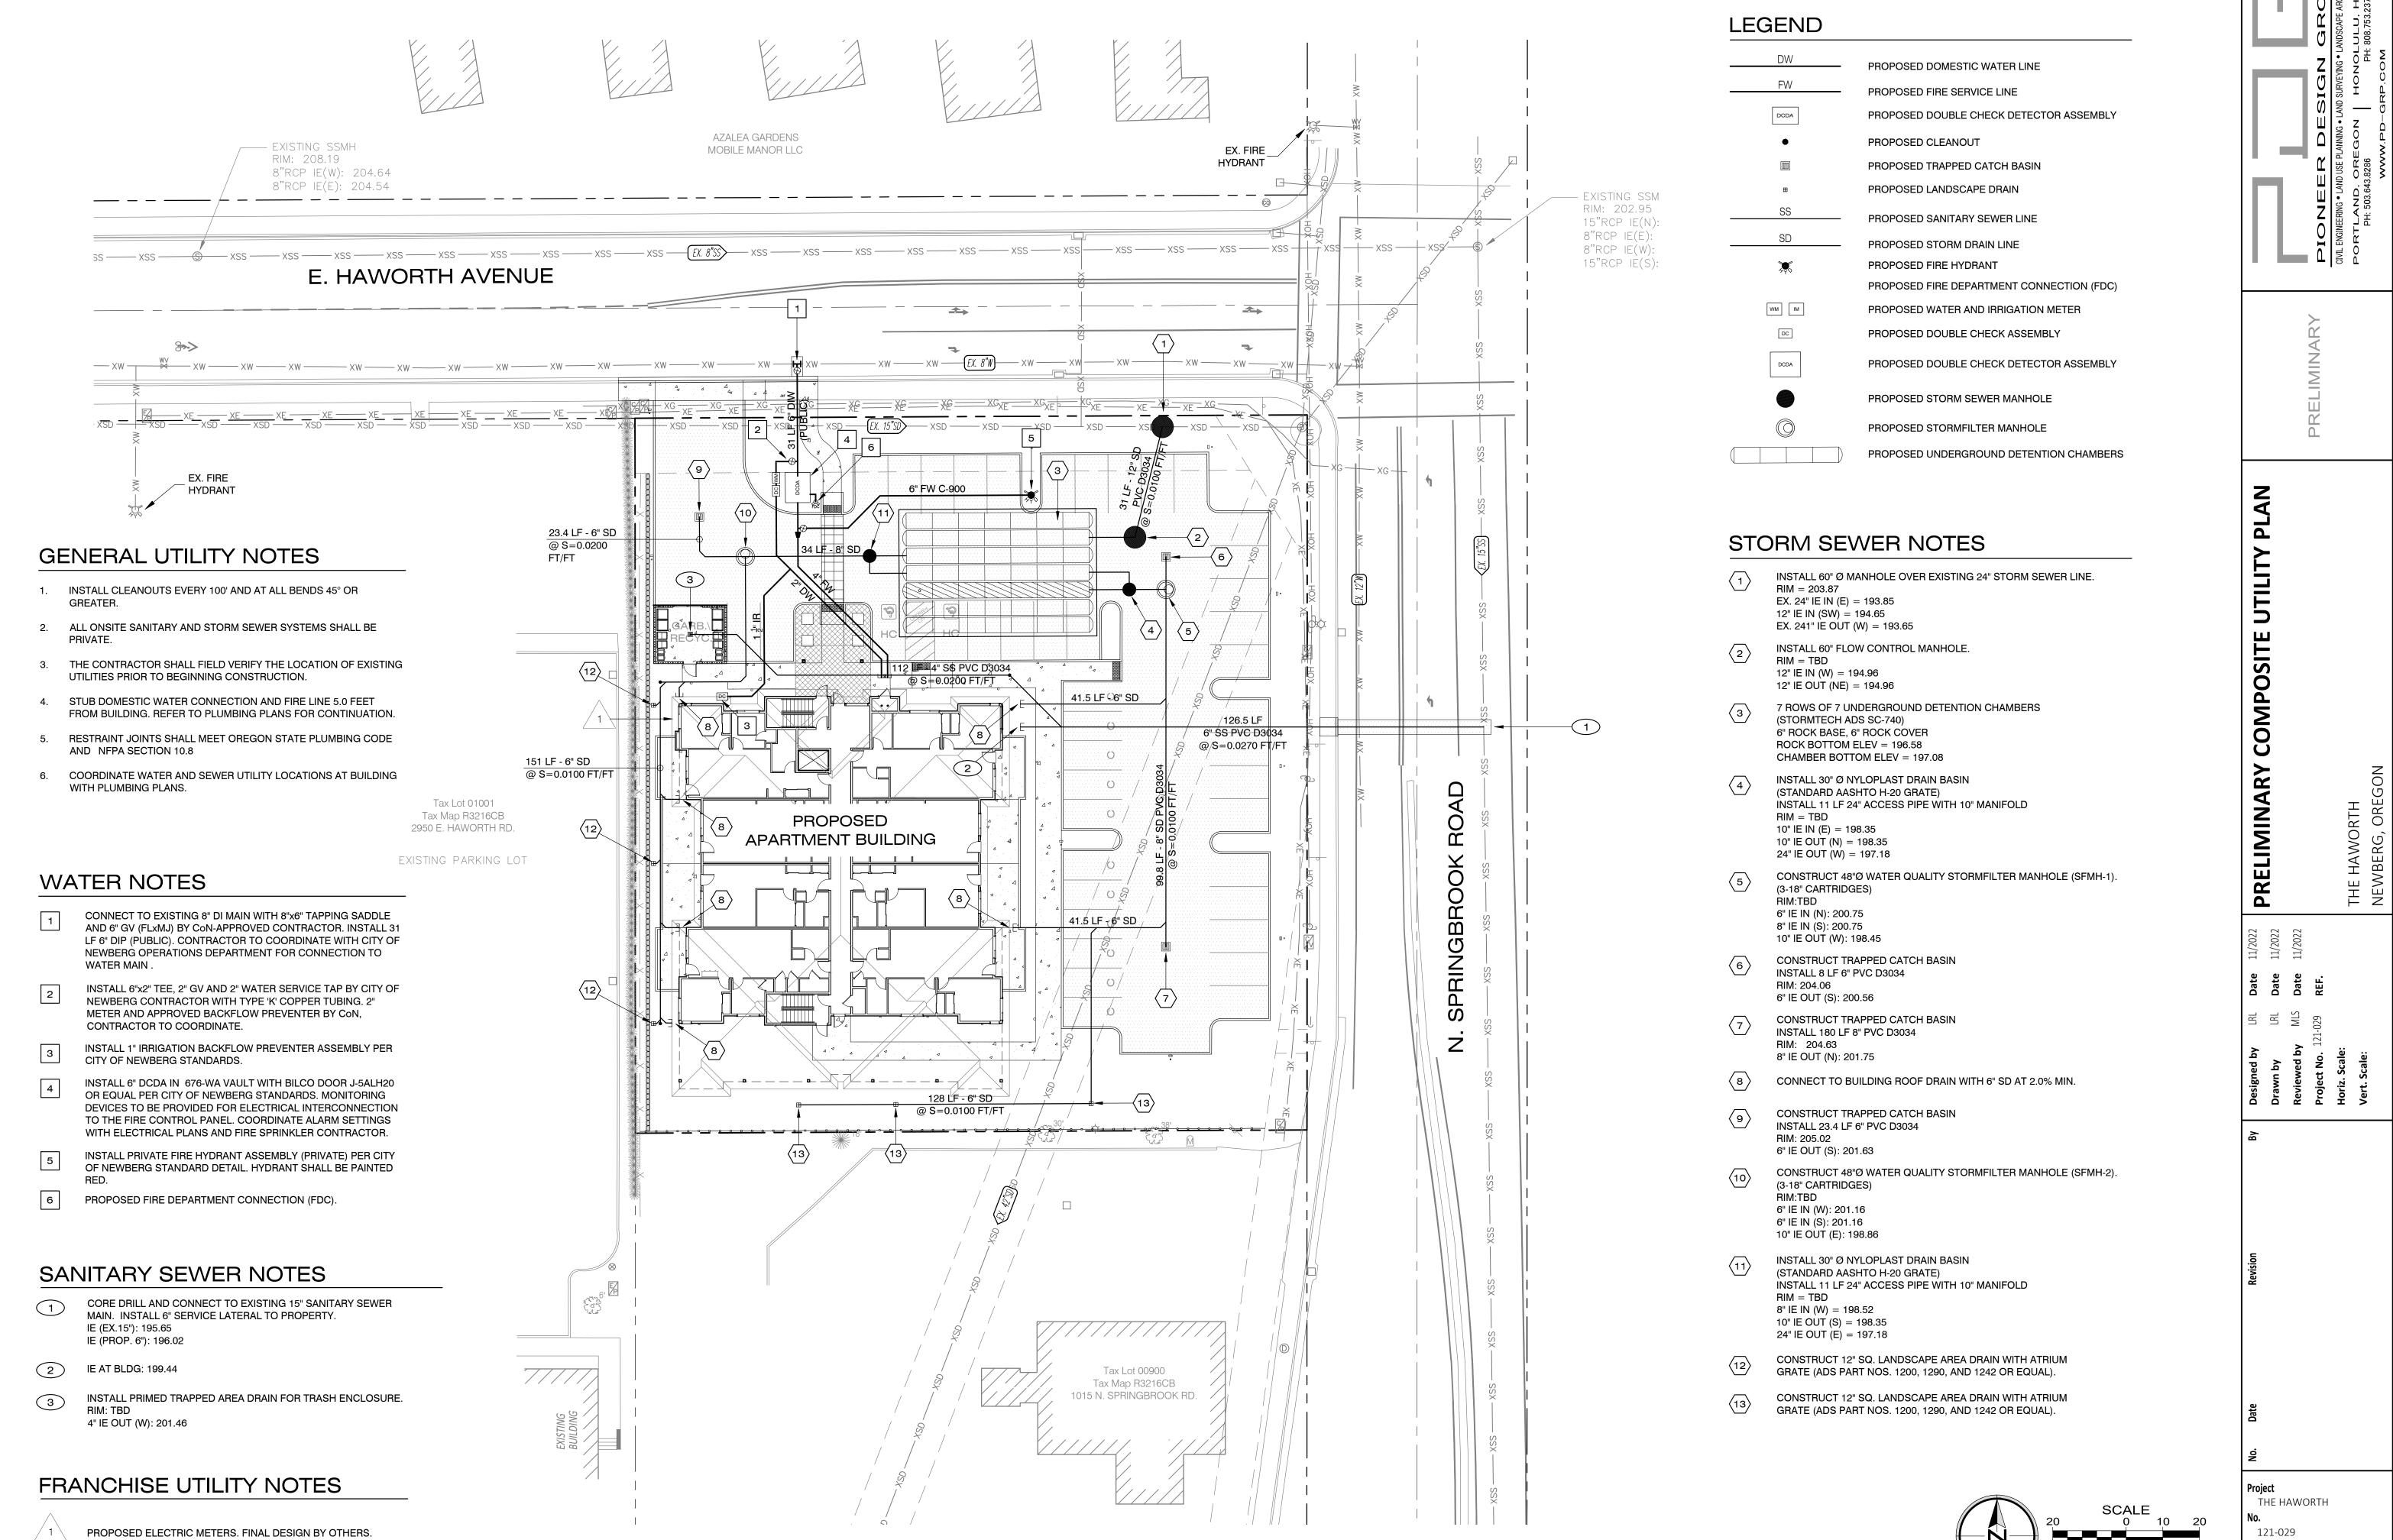

PLANNING



● ● ● PROPOSED PEDESTRIAN CIRCULATION O O EXISTING PEDESTRIAN CIRCULATION

PROPOSED SUBDIVISION BOUNDARY

PROPOSED VEHICULAR / BICYCLE CIRCULATION


EXISTING VEHICULAR / BICYCLE CIRCULATION


AERIAL AND CIRCULATION PLAN (SITE ANALYSIS DIAGRAM)


Project THE HAWORTH


PLANNING


P6.0

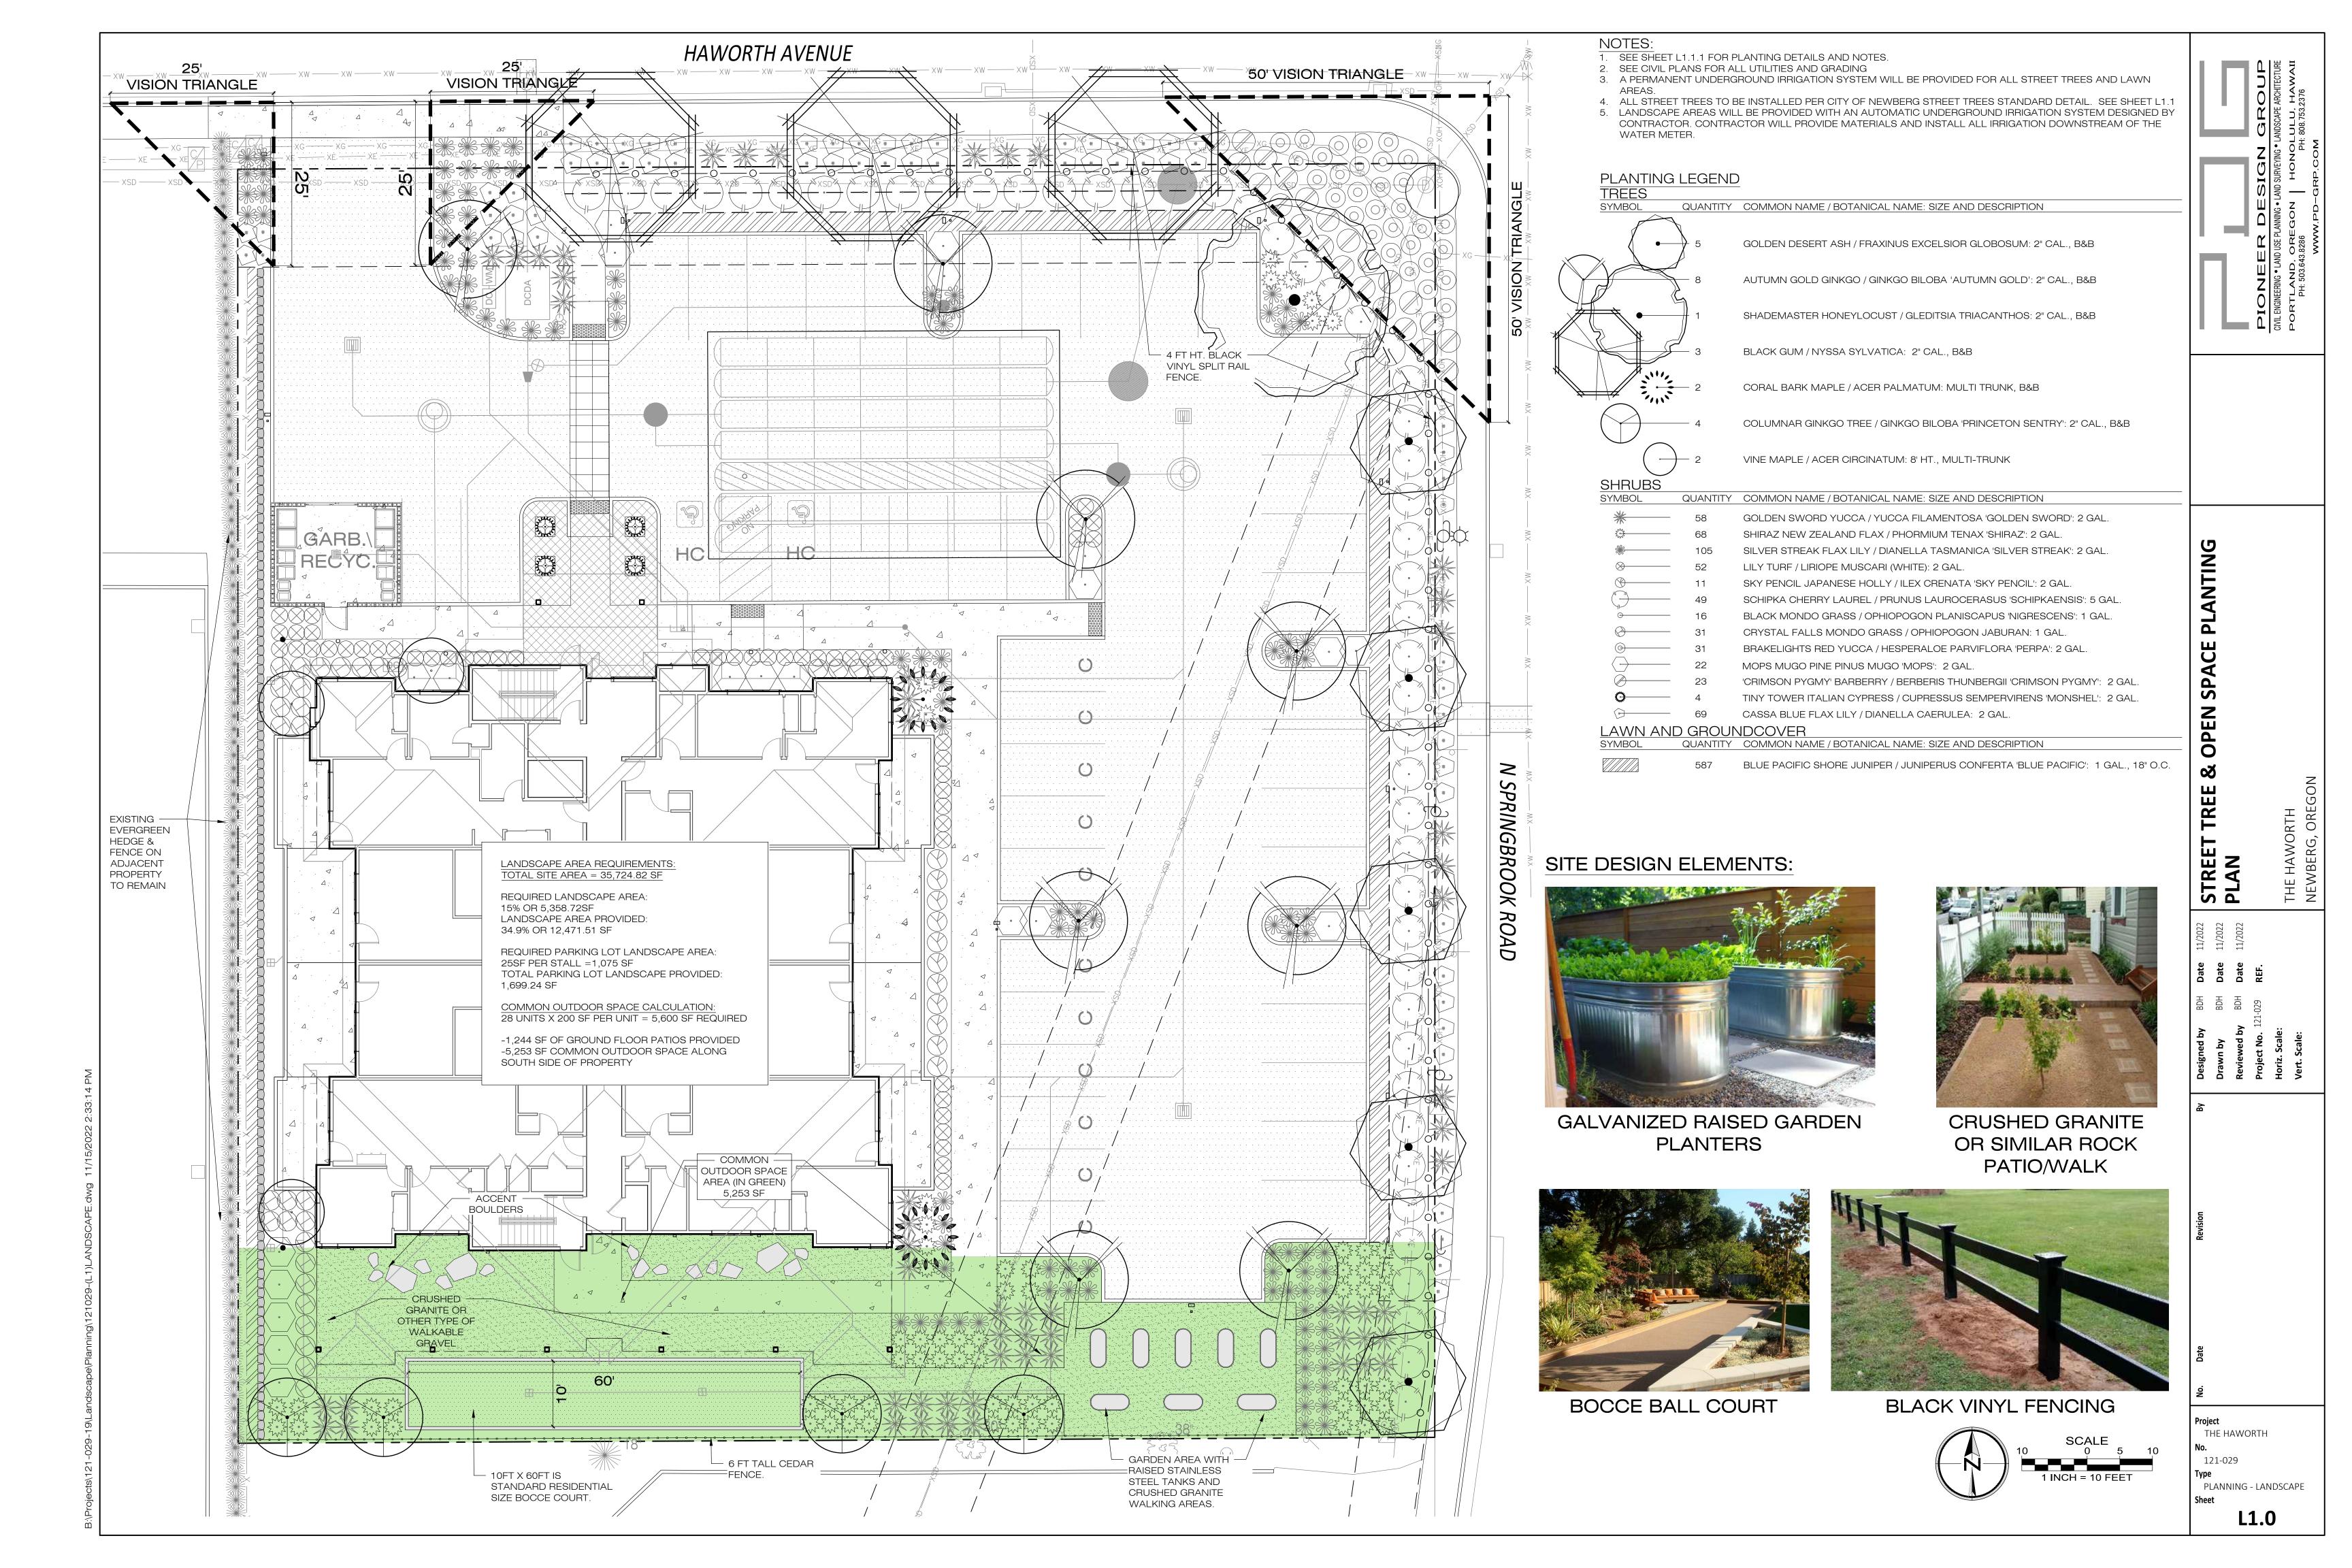


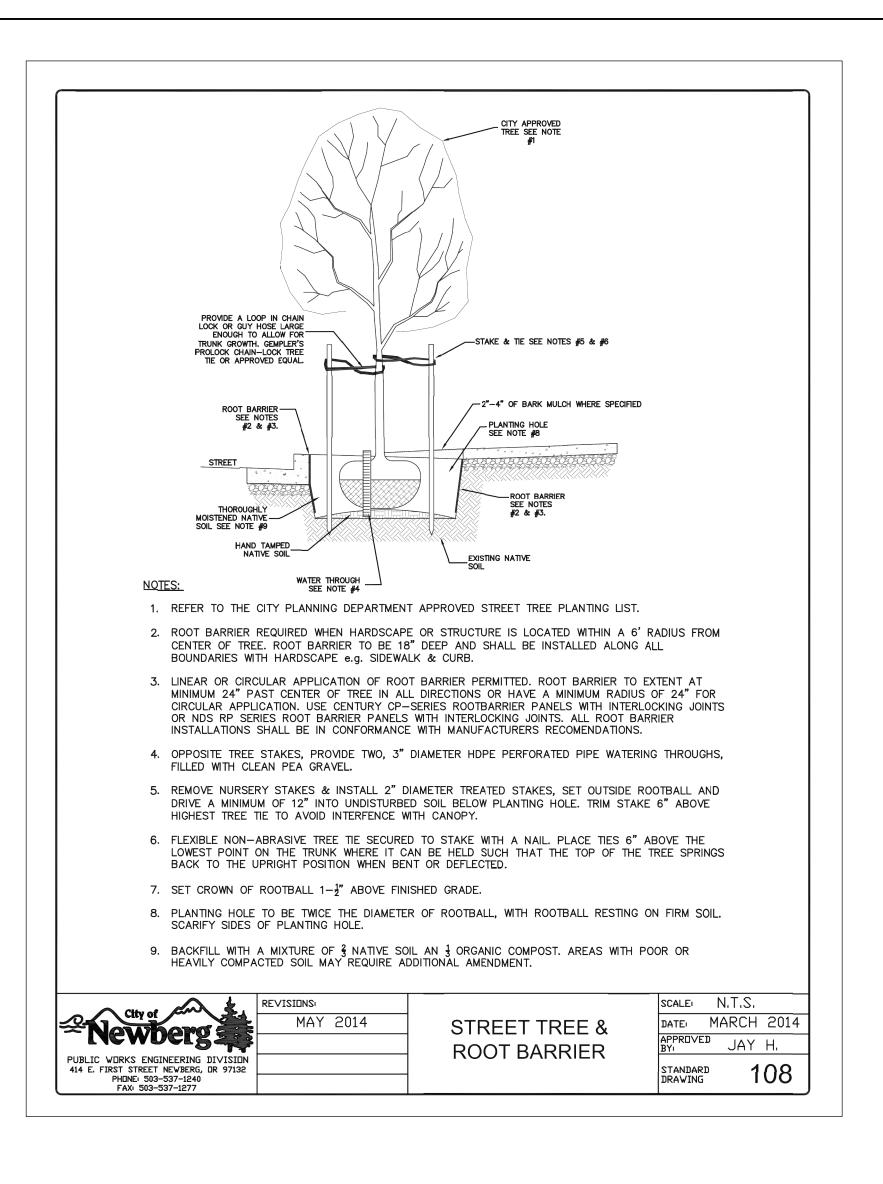

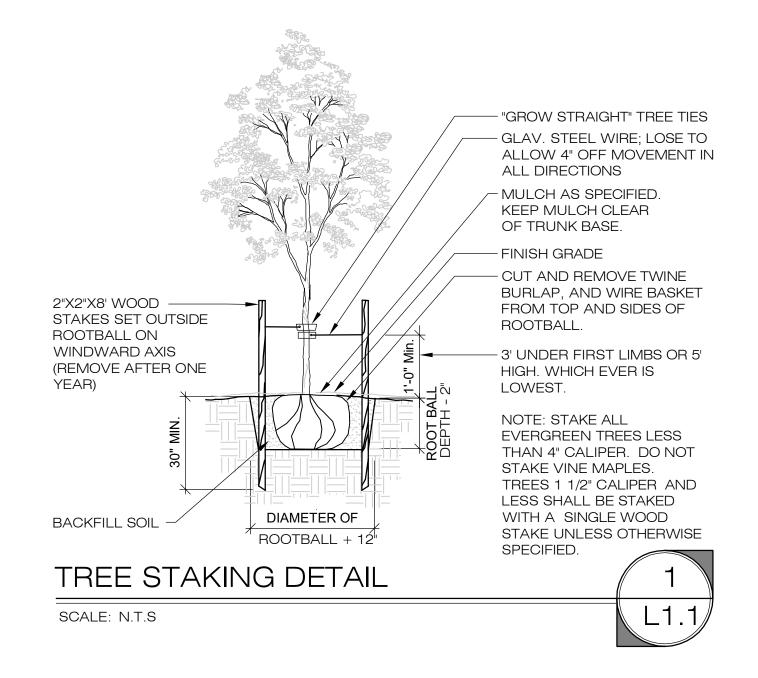

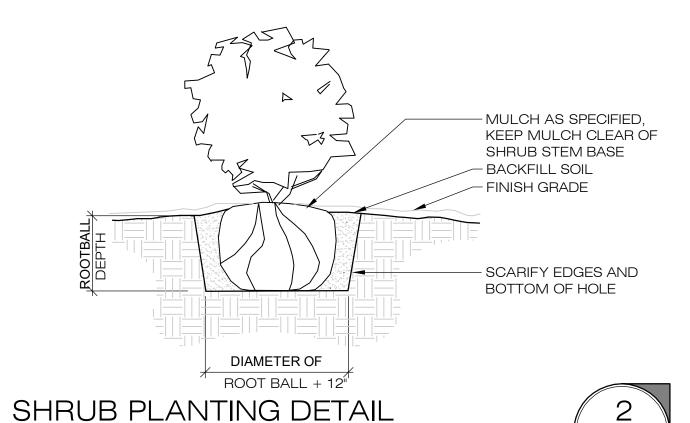

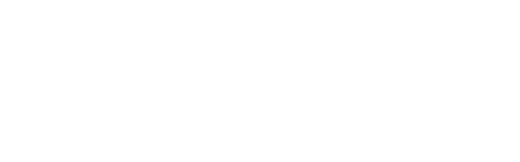

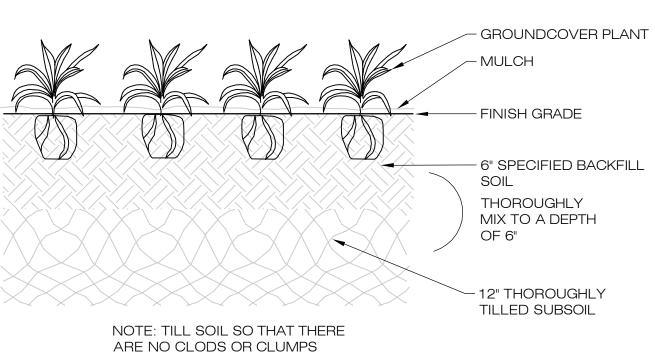

GROUNDCOVER PLANTING DETAIL

LARGER THAN 1 1/2" DIA.

SCALE: N.T.S

SCALE: N.T.S



GENERAL NOTES: LANDSCAPE PLAN

- 1. THE CONTRACTOR SHALL VERIFY WITH OWNER AND UTILITY COMPANIES THE LOCATIONS OF ALL UTILITIES PRIOR TO CONSTRUCTION. THE CONTRACTOR SHALL DETERMINE IN THE FIELD THE ACTUAL LOCATIONS AND ELEVATIONS OF ALL EXISTING UTILITIES WHETHER SHOWN ON THE PLANS OR NOT. THE CONTRACTOR SHALL CALL UTILITY PROTECTION SERVICE 72 HOURS PRIOR TO CONSTRUCTION.
- 2. THE CONTRACTOR SHALL EXAMINE FINISH SURFACE, GRADES, TOPSOIL QUALITY AND DEPTH. DO NOT START ANY WORK UNTIL UNSATISFACTORY CONDITIONS HAVE BEEN CORRECTED. VERIFY LIMITS OF WORK BEFORE STARTING.
- 3. CONTRACTOR TO REPORT ALL DAMAGES TO EXISTING CONDITIONS AND INCONSISTENCIES WITH PLANS TO ODR.
- 4. ALL PLANT MASSES TO BE CONTAINED WITHIN A BARK MULCH BED, UNLESS NOTED OTHERWISE.
- 5. BED EDGE TO BE NO LESS THAN 12" AND NO MORE THAN 18" FROM OUTER EDGE OF PLANT MATERIAL BRANCHING. WHERE GROUND-COVER OCCURS, PLANT TO LIMITS OF AREA AS SHOWN.
- 6. CONTRACTOR SHALL MAINTAIN POSITIVE DRAINAGE IN ALL LANDSCAPE BEDS AND ALL LAWN AREAS.
- 7. CONTRACTOR TO FINE GRADE AND ROCK-HOUND ALL TURF AREAS PRIOR TO SEEDING, TO PROVIDE A SMOOTH AND CONTINUAL SURFACE, FREE OF IRREGULARITIES (BUMPS OR DEPRESSIONS) & EXTRANEOUS MATERIAL OR DEBRIS.
- 8. QUANTITIES SHOWN ARE INTENDED TO ASSIST CONTRACTOR IN EVALUATING THEIR OWN TAKE-OFFS AND ARE NOT GUARANTEED AS ACCURATE REPRESENTATIONS OF REQUIRED MATERIALS. THE CONTRACTOR SHALL BE RESPONSIBLE FOR HIS BID QUANTITIES AS REQUIRED BY THE PLANS AND SPECIFICATIONS. IF THERE IS A DISCREPANCY BETWEEN THE NUMBER LABELED ON THE PLANT TAG AND THE QUANTITY OF GRAPHIC SYMBOLS SHOWN, THE GRAPHIC SYMBOL QUANTITY SHALL GOVERN.
- 9. COORDINATE LANDSCAPE INSTALLATION WITH INSTALLATION OF UNDERGROUND SPRINKLER AND DRAINAGE SYSTEMS.
- 10. WITH THE EXCEPTION OF THOSE TREES INDICATED ON THE TREE REMOVAL PLAN, CONTRACTOR SHALL NOT REMOVE ANY TREES DURING CONSTRUCTION WITHOUT THE EXPRESS WRITTEN CONSENT OF THE ODR. EXISTING VEGETATION TO REMAIN SHALL BE PROTECTED AS DIRECTED BY THE ODR.
- 11. WHERE PROPOSED TREE LOCATIONS OCCUR UNDER EXISTING OVERHEAD UTILITIES OR CROWD EXISTING TREES, NOTIFY ODR TO ADJUST TREE LOCATIONS.
- 12. LANDSCAPE MAINTENANCE PERIOD BEGINS IMMEDIATELY AFTER THE COMPLETION OF ALL PLANTING OPERATIONS AND WRITTEN NOTIFICATION TO THE ODR. MAINTAIN TREES, SHRUBS, LAWNS AND OTHER PLANTS UNTIL FINAL ACCEPTANCE OR 90 DAYS AFTER NOTIFICATION AND ACCEPTANCE, WHICHEVER IS LONGER.
- 13. REMOVE EXISTING WEEDS FROM PROJECT SITE PRIOR TO THE ADDITION OF ORGANIC AMENDMENTS AND FERTILIZER. APPLY AMENDMENTS AND FERTILIZER PER THE RECOMMENDATIONS OF THE SOIL ANALYSIS FROM THE SITE.
- 14. BACK FILL MATERIAL FOR TREE AND SHRUB PLANTING SHALL CONTAIN: ONE PART FINE GRADE COMPOST TO ONE PART TOPSOIL BY VOLUME, BONE MEAL PER MANUFACTURE'S RECOMMENDATION, AND SLOW RELEASE FERTILIZER PER MANUFACTURER'S RECOMMENDATION.
- 15. GROUND COVERS AND PERENNIALS SHALL BE PLANTED WITH A MAXIMUM 2 INCH COVER OF BARK MULCH WITH NO FOLIAGE COVERED.
- 16. CONTRACTOR SHALL OBTAIN WRITTEN APPROVAL FOR ALL PLANT MATERIAL SUBSTITUTIONS FROM THE LANDSCAPE ARCHITECT PRIOR TO INSTALLATION. PLANT SUBSTITUTIONS WITHOUT PRIOR WRITTEN APPROVAL THAT DO NOT COMPLY WITH THE DRAWINGS AND SPECIFICATIONS MAY BE REJECTED BY THE LANDSCAPE ARCHITECT AT NO COST TO THE OWNER. THESE ITEMS MAY BE REQUIRED TO BE REPLACED WITH PLANT MATERIALS THAT ARE IN COMPLIANCE WITH THE DRAWINGS.
- 17. ALL PLANT MATERIALS SHALL BE NURSERY GROWN WITH HEALTHY ROOT SYSTEMS AND FULL BRANCHING, DISEASE AND INSECT FREE AND WITHOUT DEFECTS SUCH AS SUN SCALD, ABRASIONS, INJURIES AND DISFIGUREMENT.
- 18. ALL PLANT MATERIAL SHALL BE INSTALLED AT THE SIZE AND QUANTITY SPECIFIED. THE LANDSCAPE ARCHITECT IS NOT RESPONSIBLE FOR SUB-STANDARD RESULTS CAUSED BY REDUCTION IN SIZE AND/OR QUANTITY OF PLANT MATERIALS.
- 19. LANDSCAPE AREAS WILL BE PROVIDED WITH AN AUTOMATIC UNDERGROUND IRRIGATION SYSTEM DESIGNED BY CONTRACTOR. CONTRACTOR WILL PROVIDE MATERIALS AND INSTALL ALL IRRIGATION DOWNSTREAM OF THE WATER METER.

	- -		PIONEER DESIGN GROUP	CIVIL ENGINEERING • LAND USE PLANNING • LAND SURVEYING • LANDSCAPE ARCHITECTURE	PORTLAND, OREGON HONOLULU, HAWAII PH: 503 643 8286	W.PD-GRP.CC
DI ANTING DETAILS & MOTES					THE HAWORTH	NEWBERG, OREGON
Designed by BDH Date 11/2022	Drawn by BDH Date 11/2022	Reviewed by BDH Date 11/2022	Project No. 121-029 REF.	Horiz. Scale:	Vert. Scale:	
No. Date Revision By						
No. 1: Type	HE H 21-02	29	DRTH	NDS:	CAPE	