
GARFIELD ST 8-LOT SUBDIVISION TYPE III SITE IMPROVEMENTS LAND USE APPLICATION SUB322-0001 100 S GARFIELD ST, NEWBERG, OR 97132

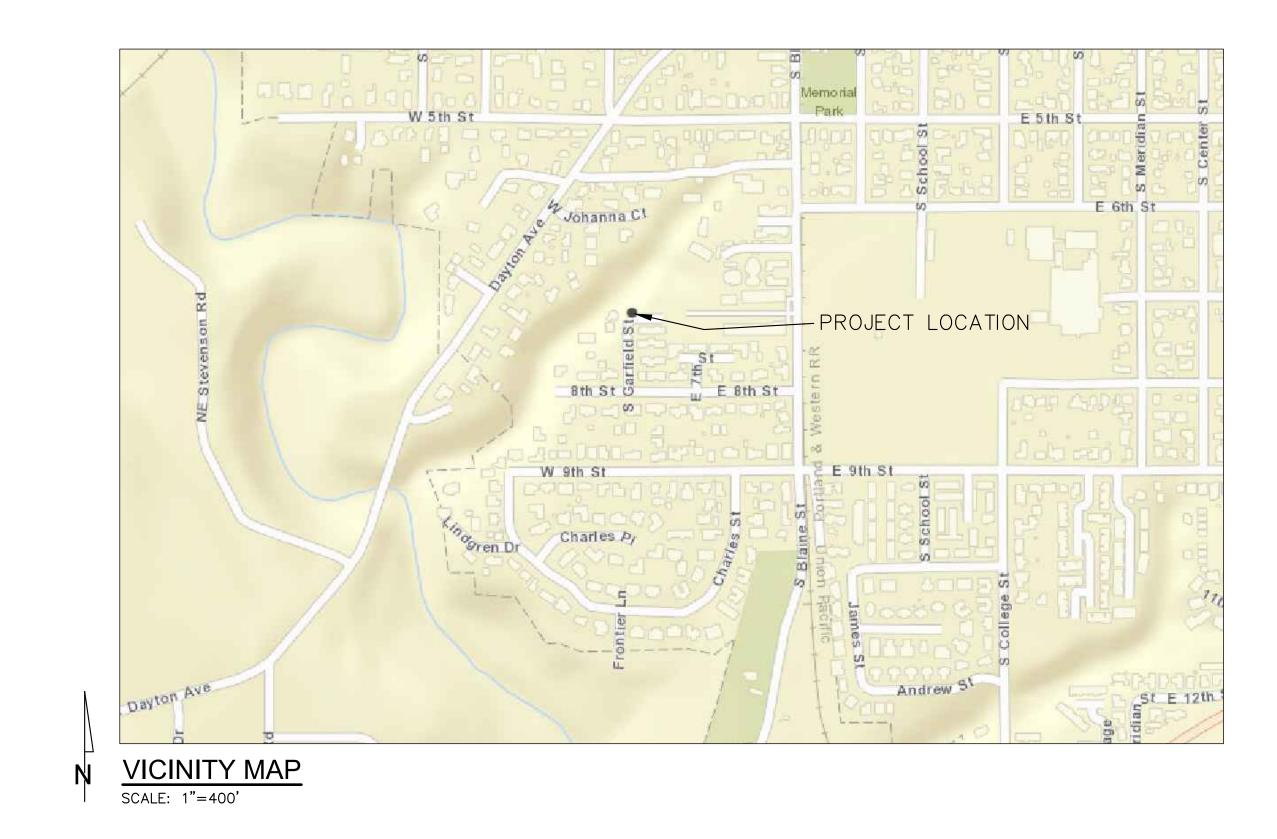

SHEET INDEX

- 1 COVER SHEET
- 2 EXISTING CONDITIONS & DEMO PLAN
- 3 PRELIMINARY PLAT
- 4 PRELIMINARY SITE & UTILITY PLAN
- 5 PRELIMINARY GRADING & ESC PLAN
- 6 MITIGATION & RE-PLANTING PLAN
- 7 ESC DETAILS & NOTES

PROJECT ENGINEER

KELLI A. GROVER, P.E. FIRWOOD DESIGN GROUP, LLC 359 E. HISTORIC COLUMBIA RIVER HWY. TROUTDALE, OR 97060 PHONE: (503) 668-3737 EMAIL: kg@firwooddesign.com EMAIL: scottholden2007@outlook.com

PROJECT SURVEYOR

359 EAST HISTORIC COLUMBIA RIVER HIGHWAY TROUTDALE, OREGON 97060

BUS: (503) 668-3737 + FAX: (503) 668-3788

DAVE ROEGER, PLS CMT SURVEYING & CONSULTING 20330 SE HIGHWAY 212 DAMASCUS, OR 97089 PHONE: (503) 850-4672 EMAIL: dave@cmtsc.net

OWNER

SCOTT HOLDEN 100 S GARFIELD ST NEWBERG, OR 97132

PHONE: (503) 502-8006

LEGAL DESCRIPTION:

TAX LOT 4690 MAP # R3219DB YAMHILL COUNTY, OREGON

STANDARD 6" CURB PAVEMENT SAWCUT AC PAVEMENT CONCRETE SIDEWALK VEGETATED STORMWATER PLANTER WATER SERVICE & METER DEAD−END BLOWOFF ⊗ VALVE 🕸 SANITARY SEWER LINE SANITARY MANHOLE S

PROPOSED LEGEND

ROAD CENTERLINE

EASEMENT -----

SANITARY CLEANOUT O STORM DRAIN PIPE

CURB INLET STORM DRAIN MANHOLE (D) MAJOR CONTOUR — 100 —

MINOR CONTOUR _____101 ____

STREET LIGHT





			DRAWN: DES	DESIGNE	D:	CHECKED:	
			SCALE: AS S	S SHOWN DATE:		ANUARY 2023	
DATE:	NO.	REVISION	PROJECT NO. E21-049				





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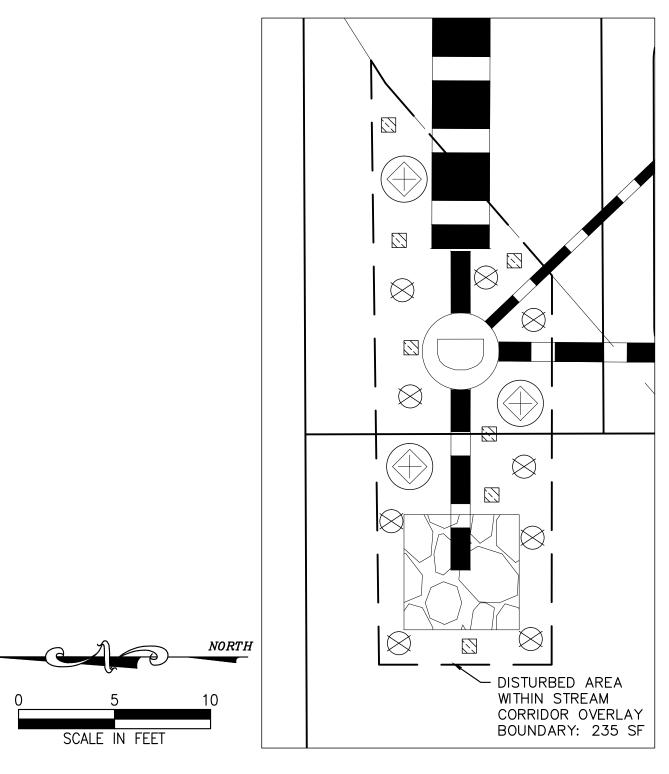
COVER SHEET 8-LOT SUBDIVISION



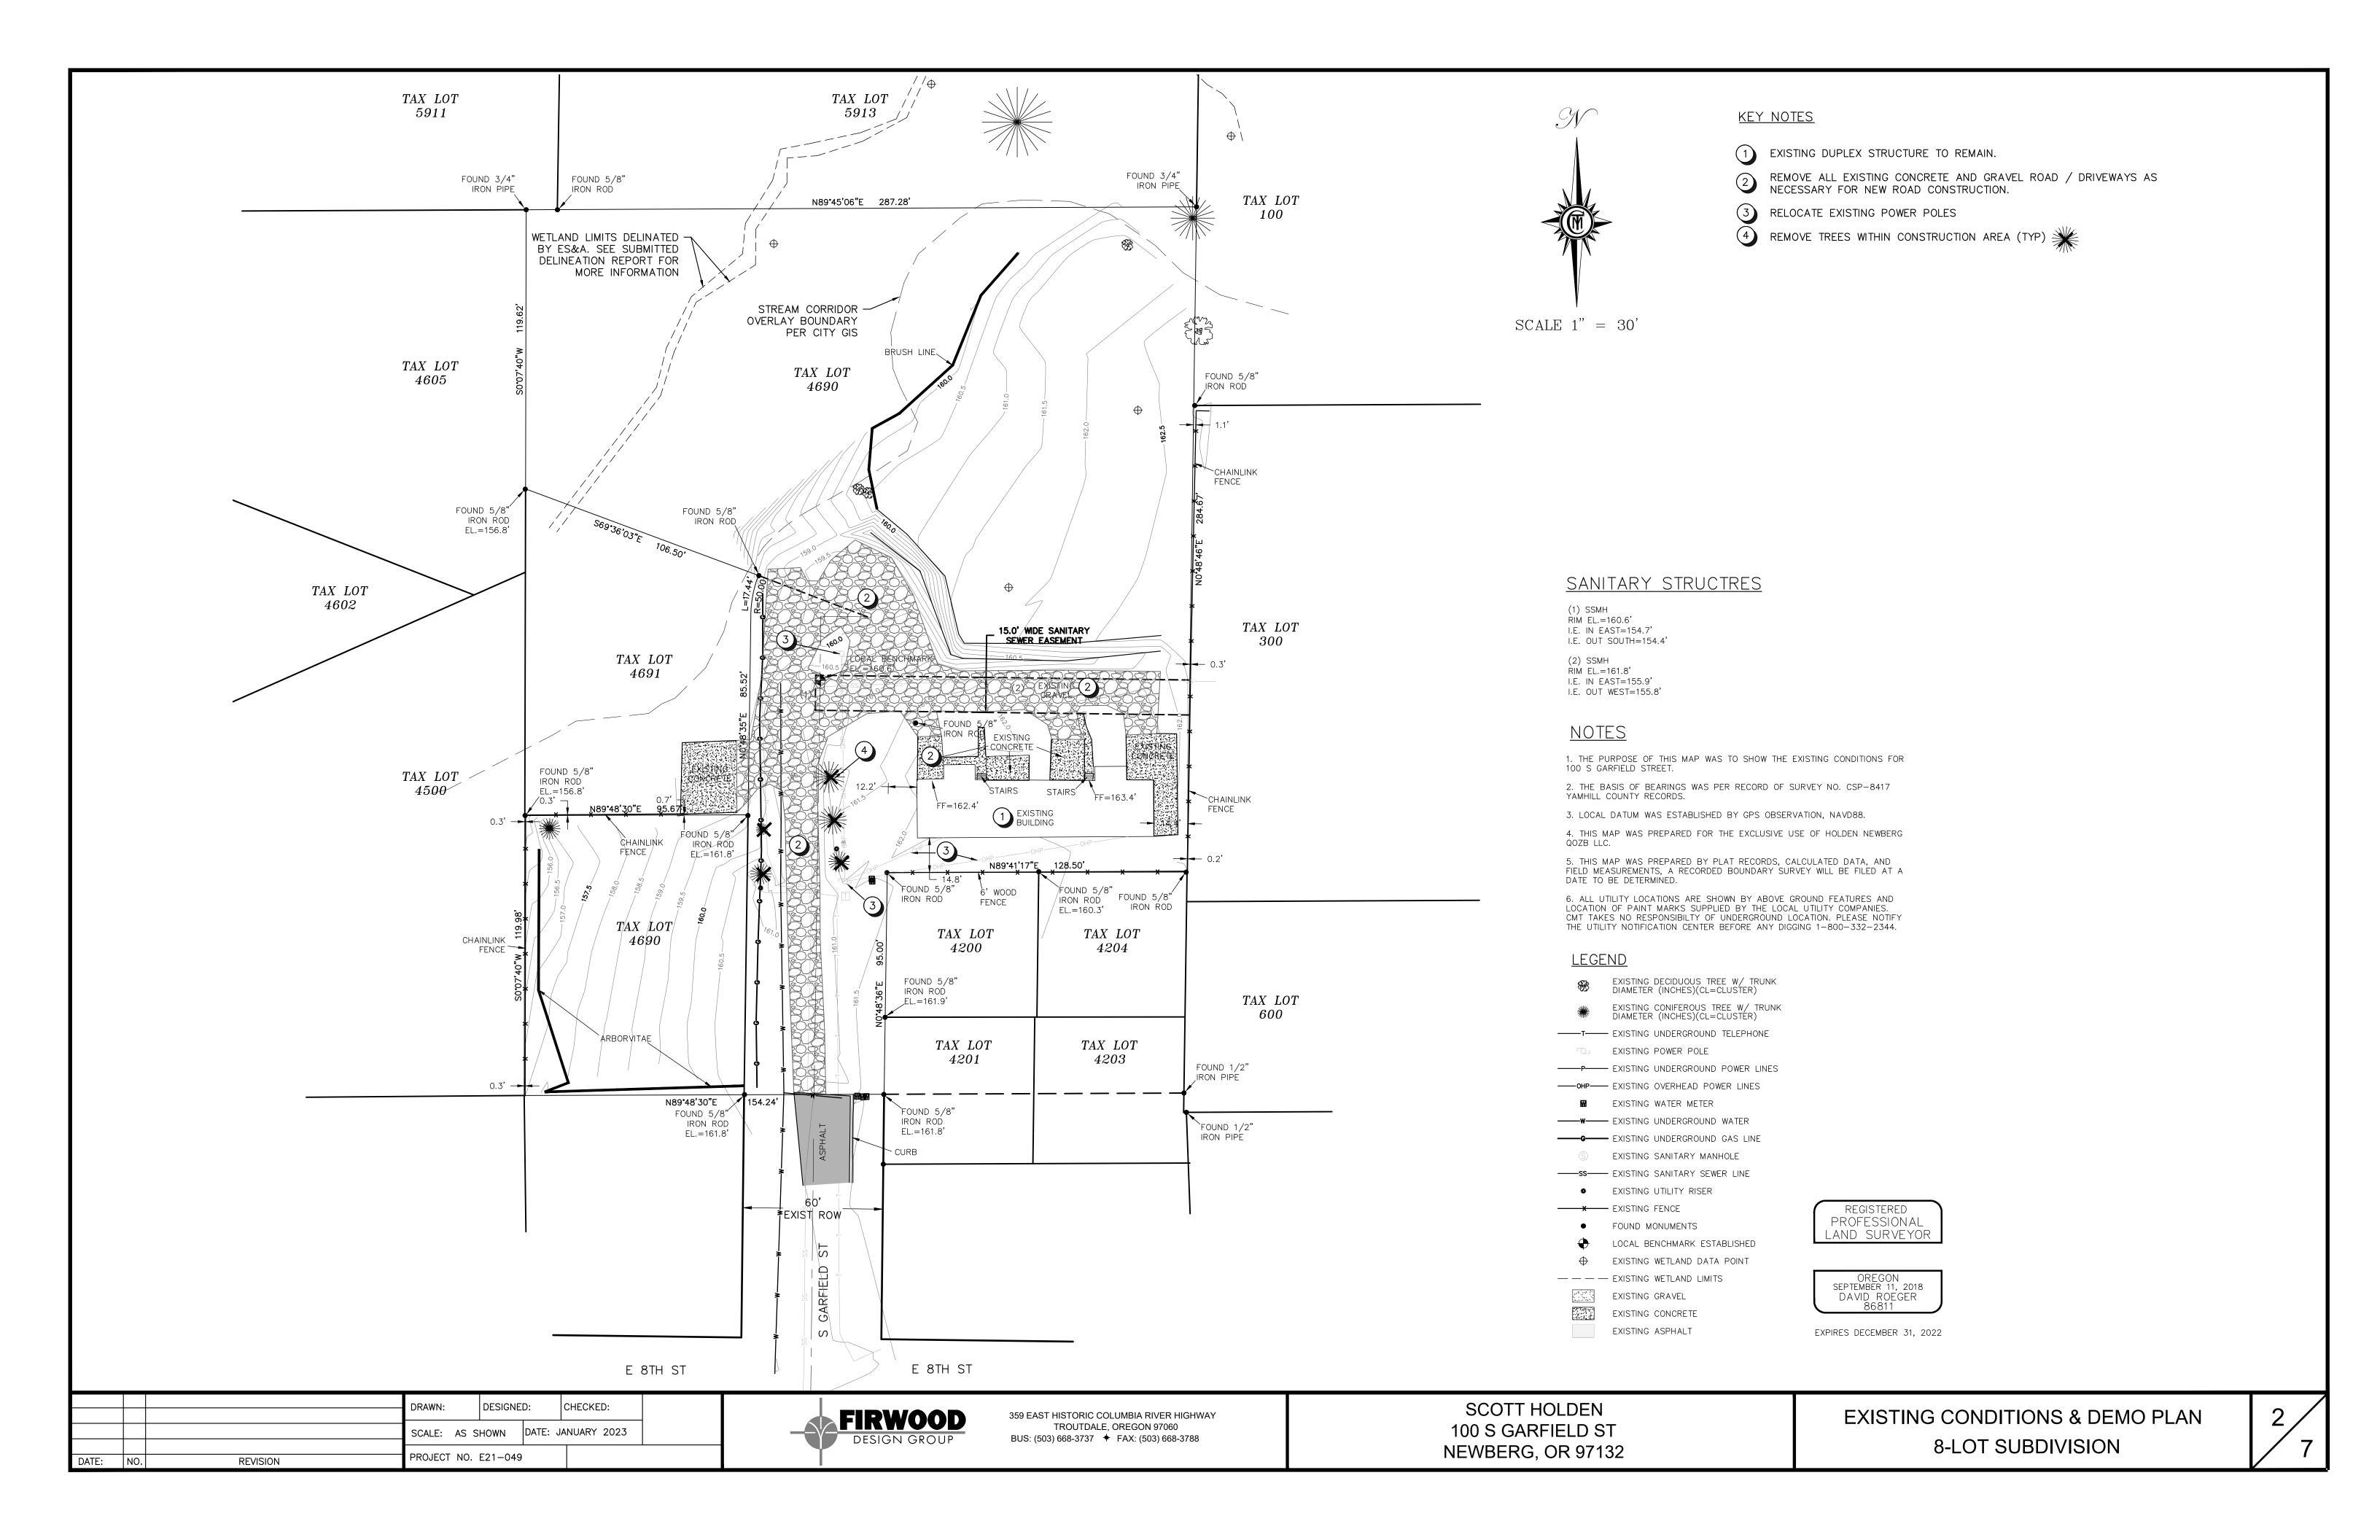

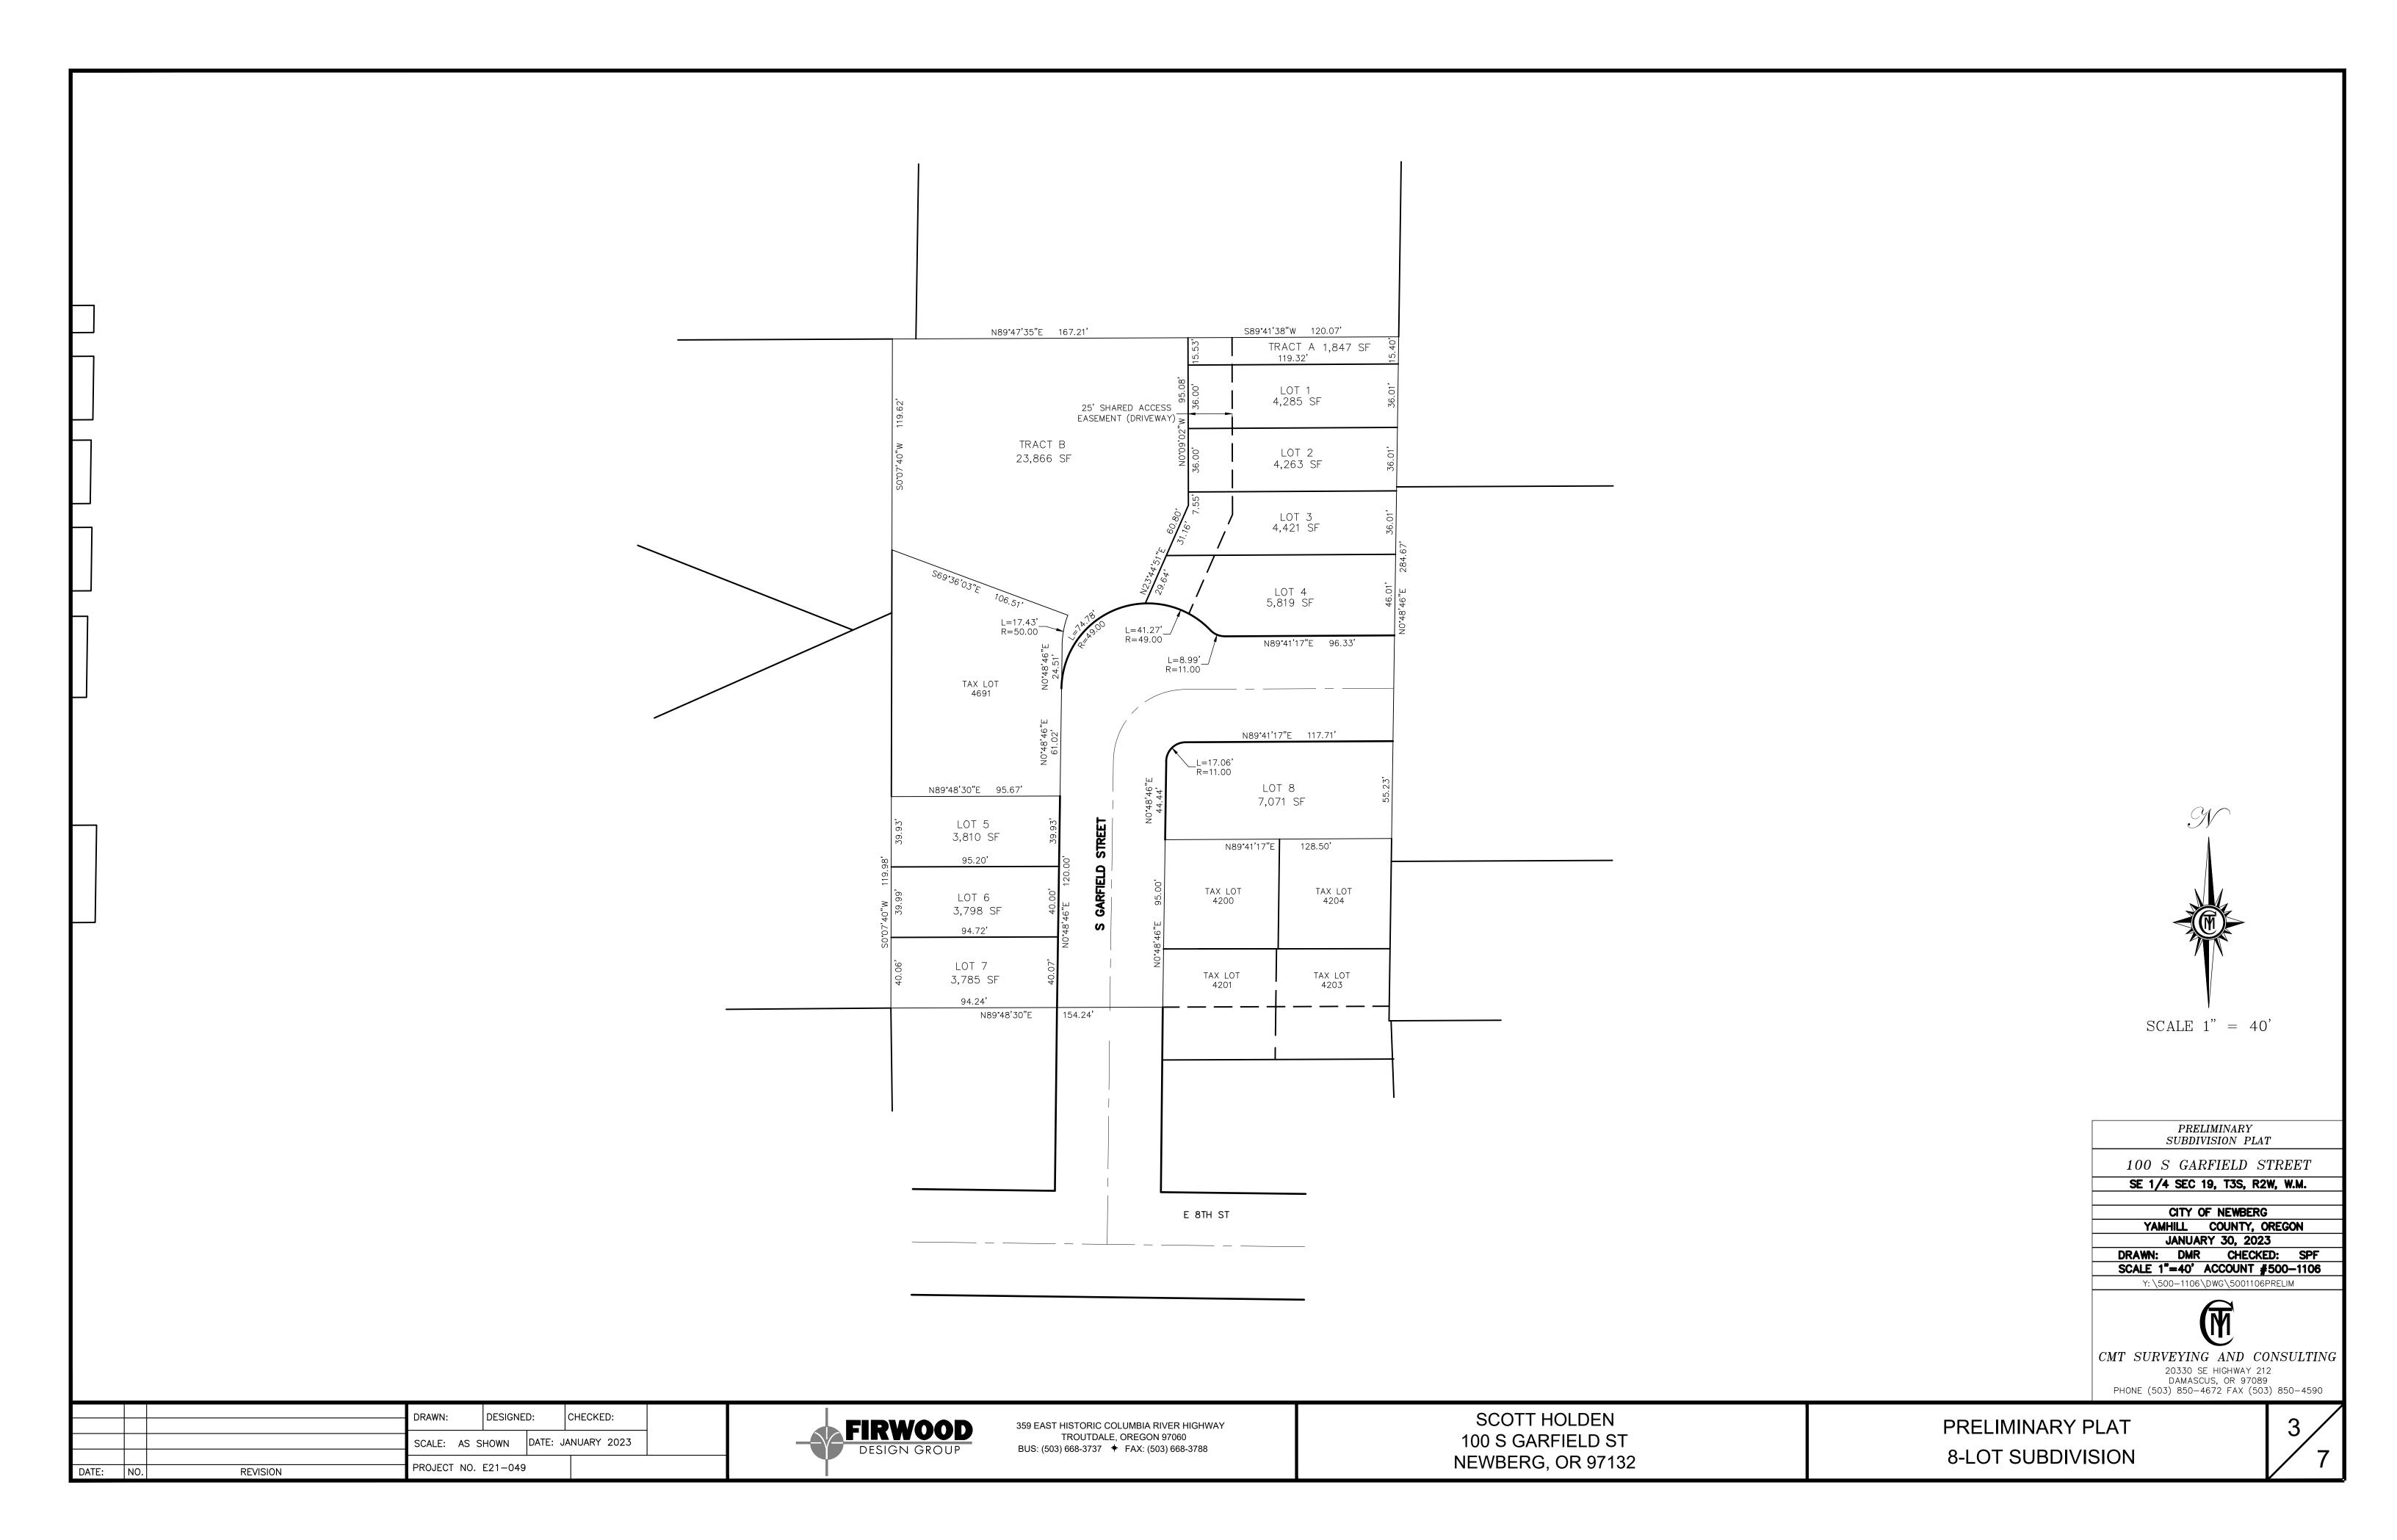

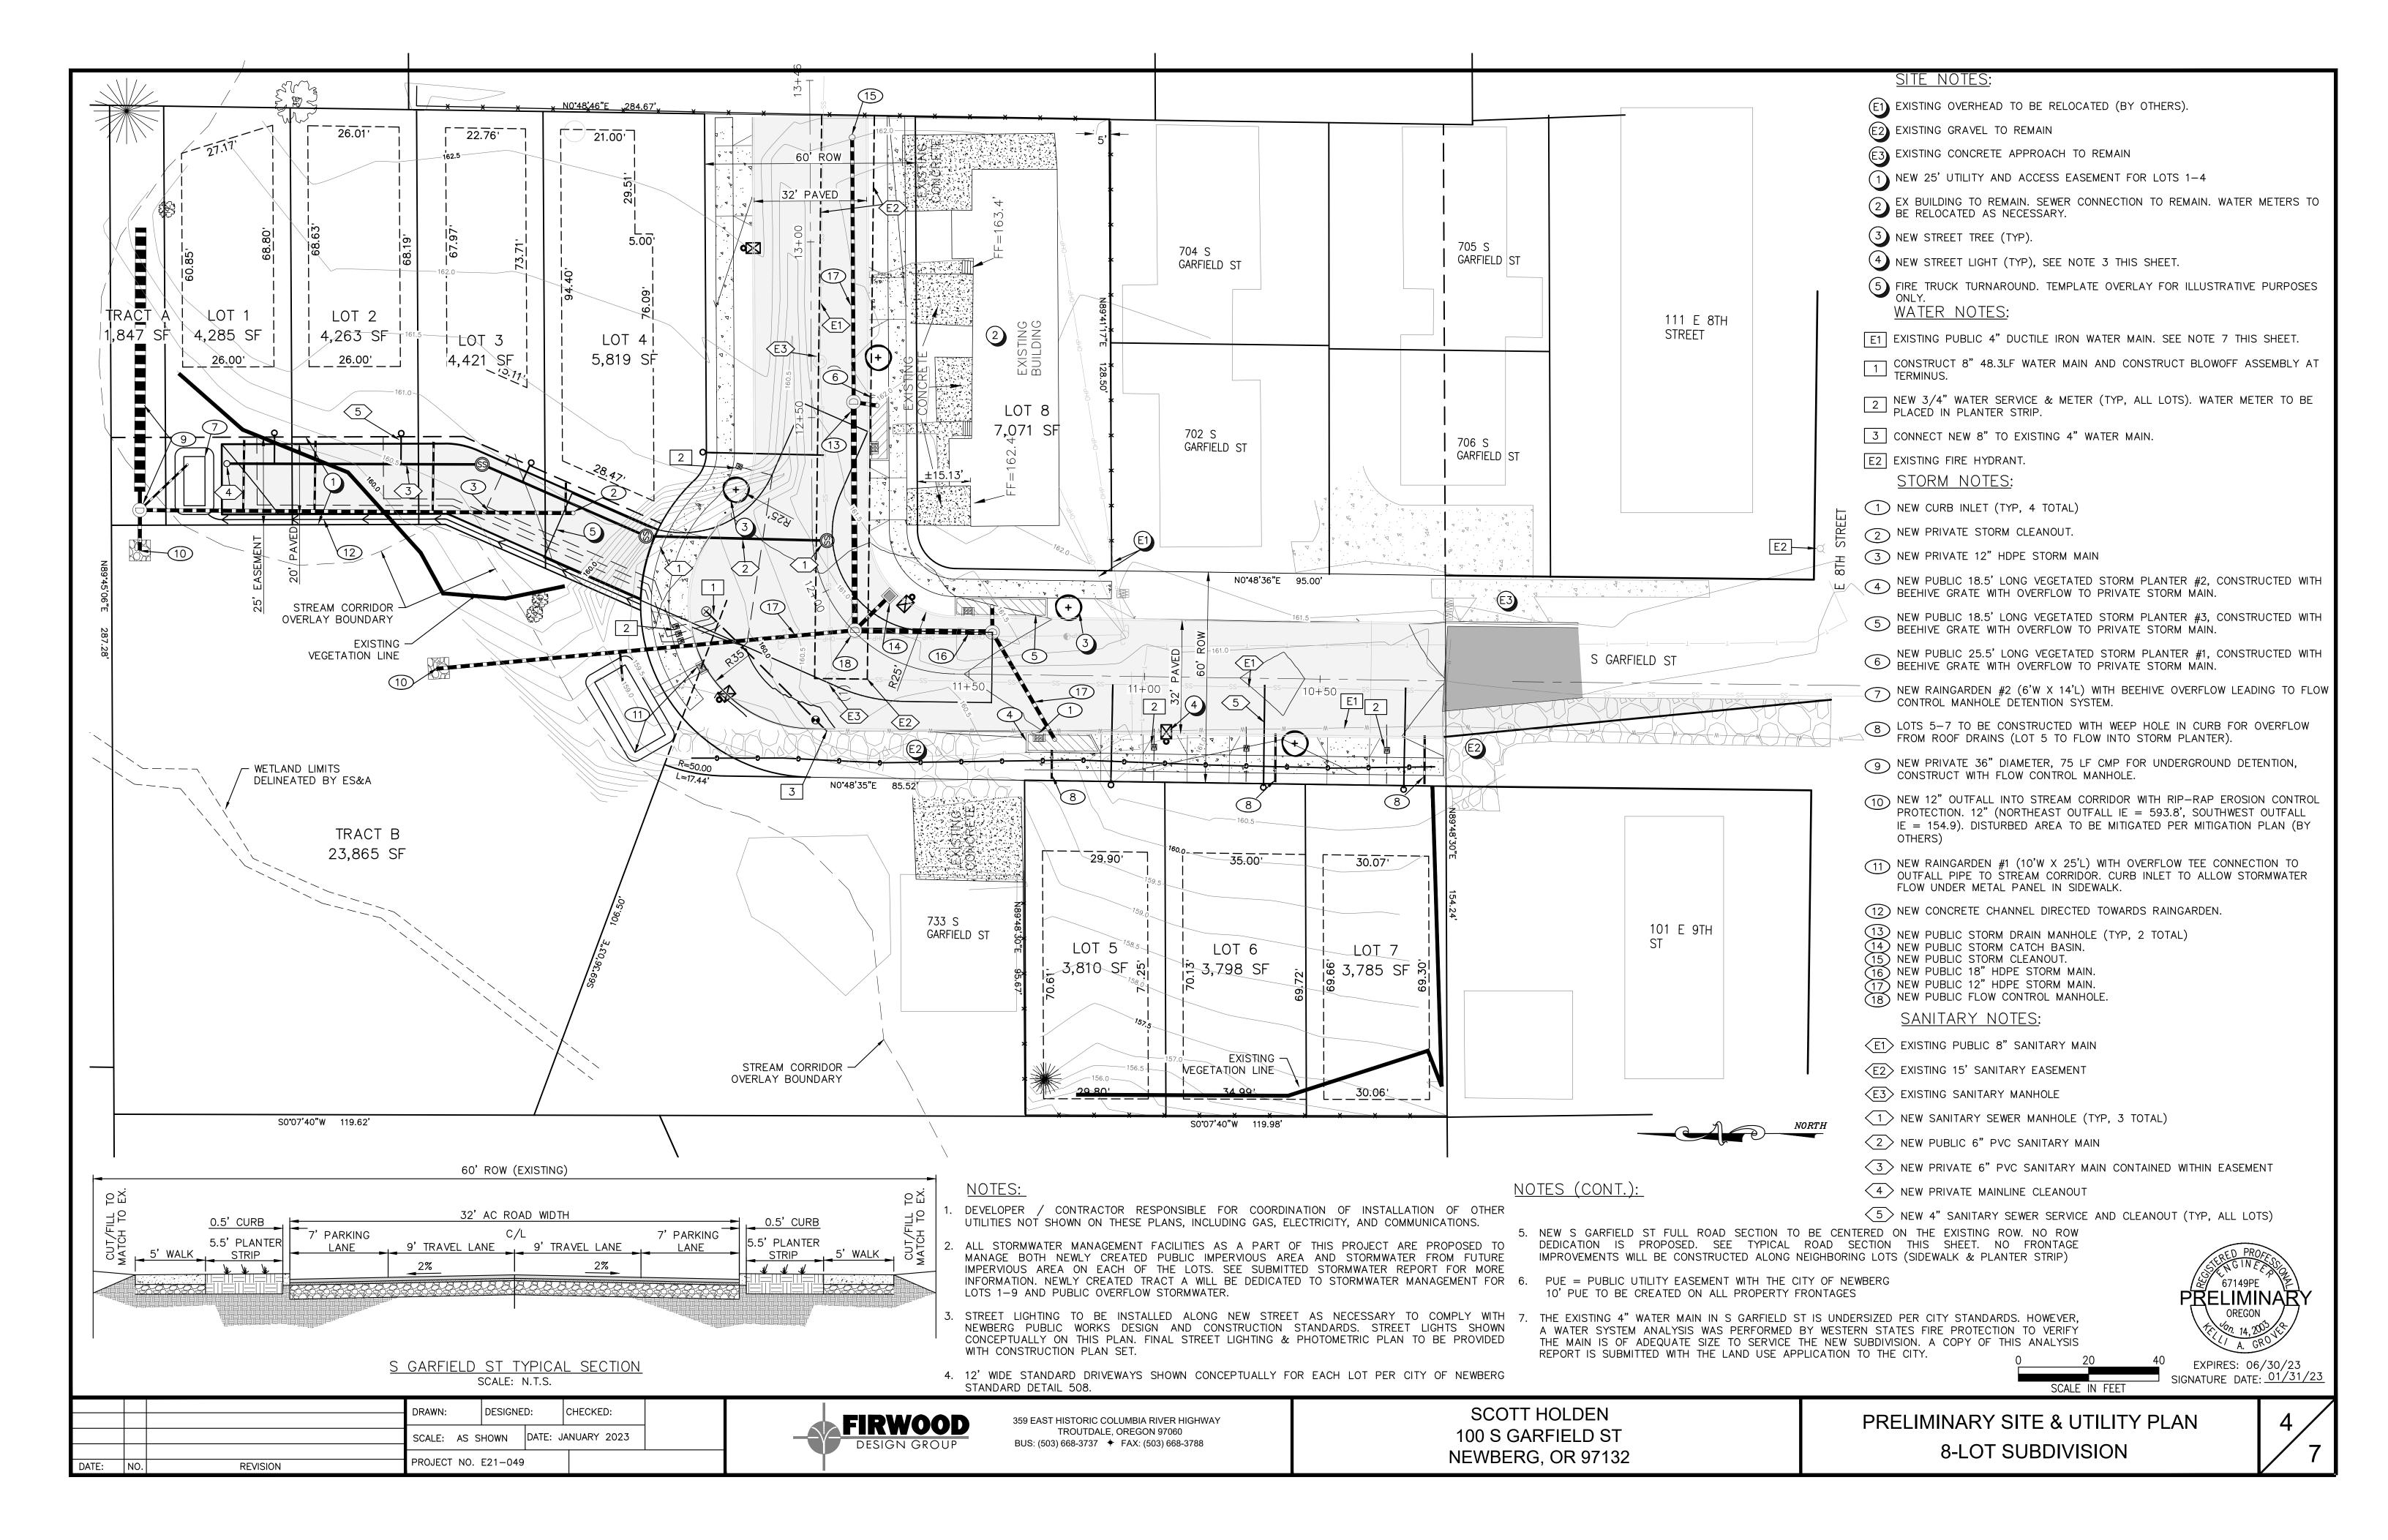

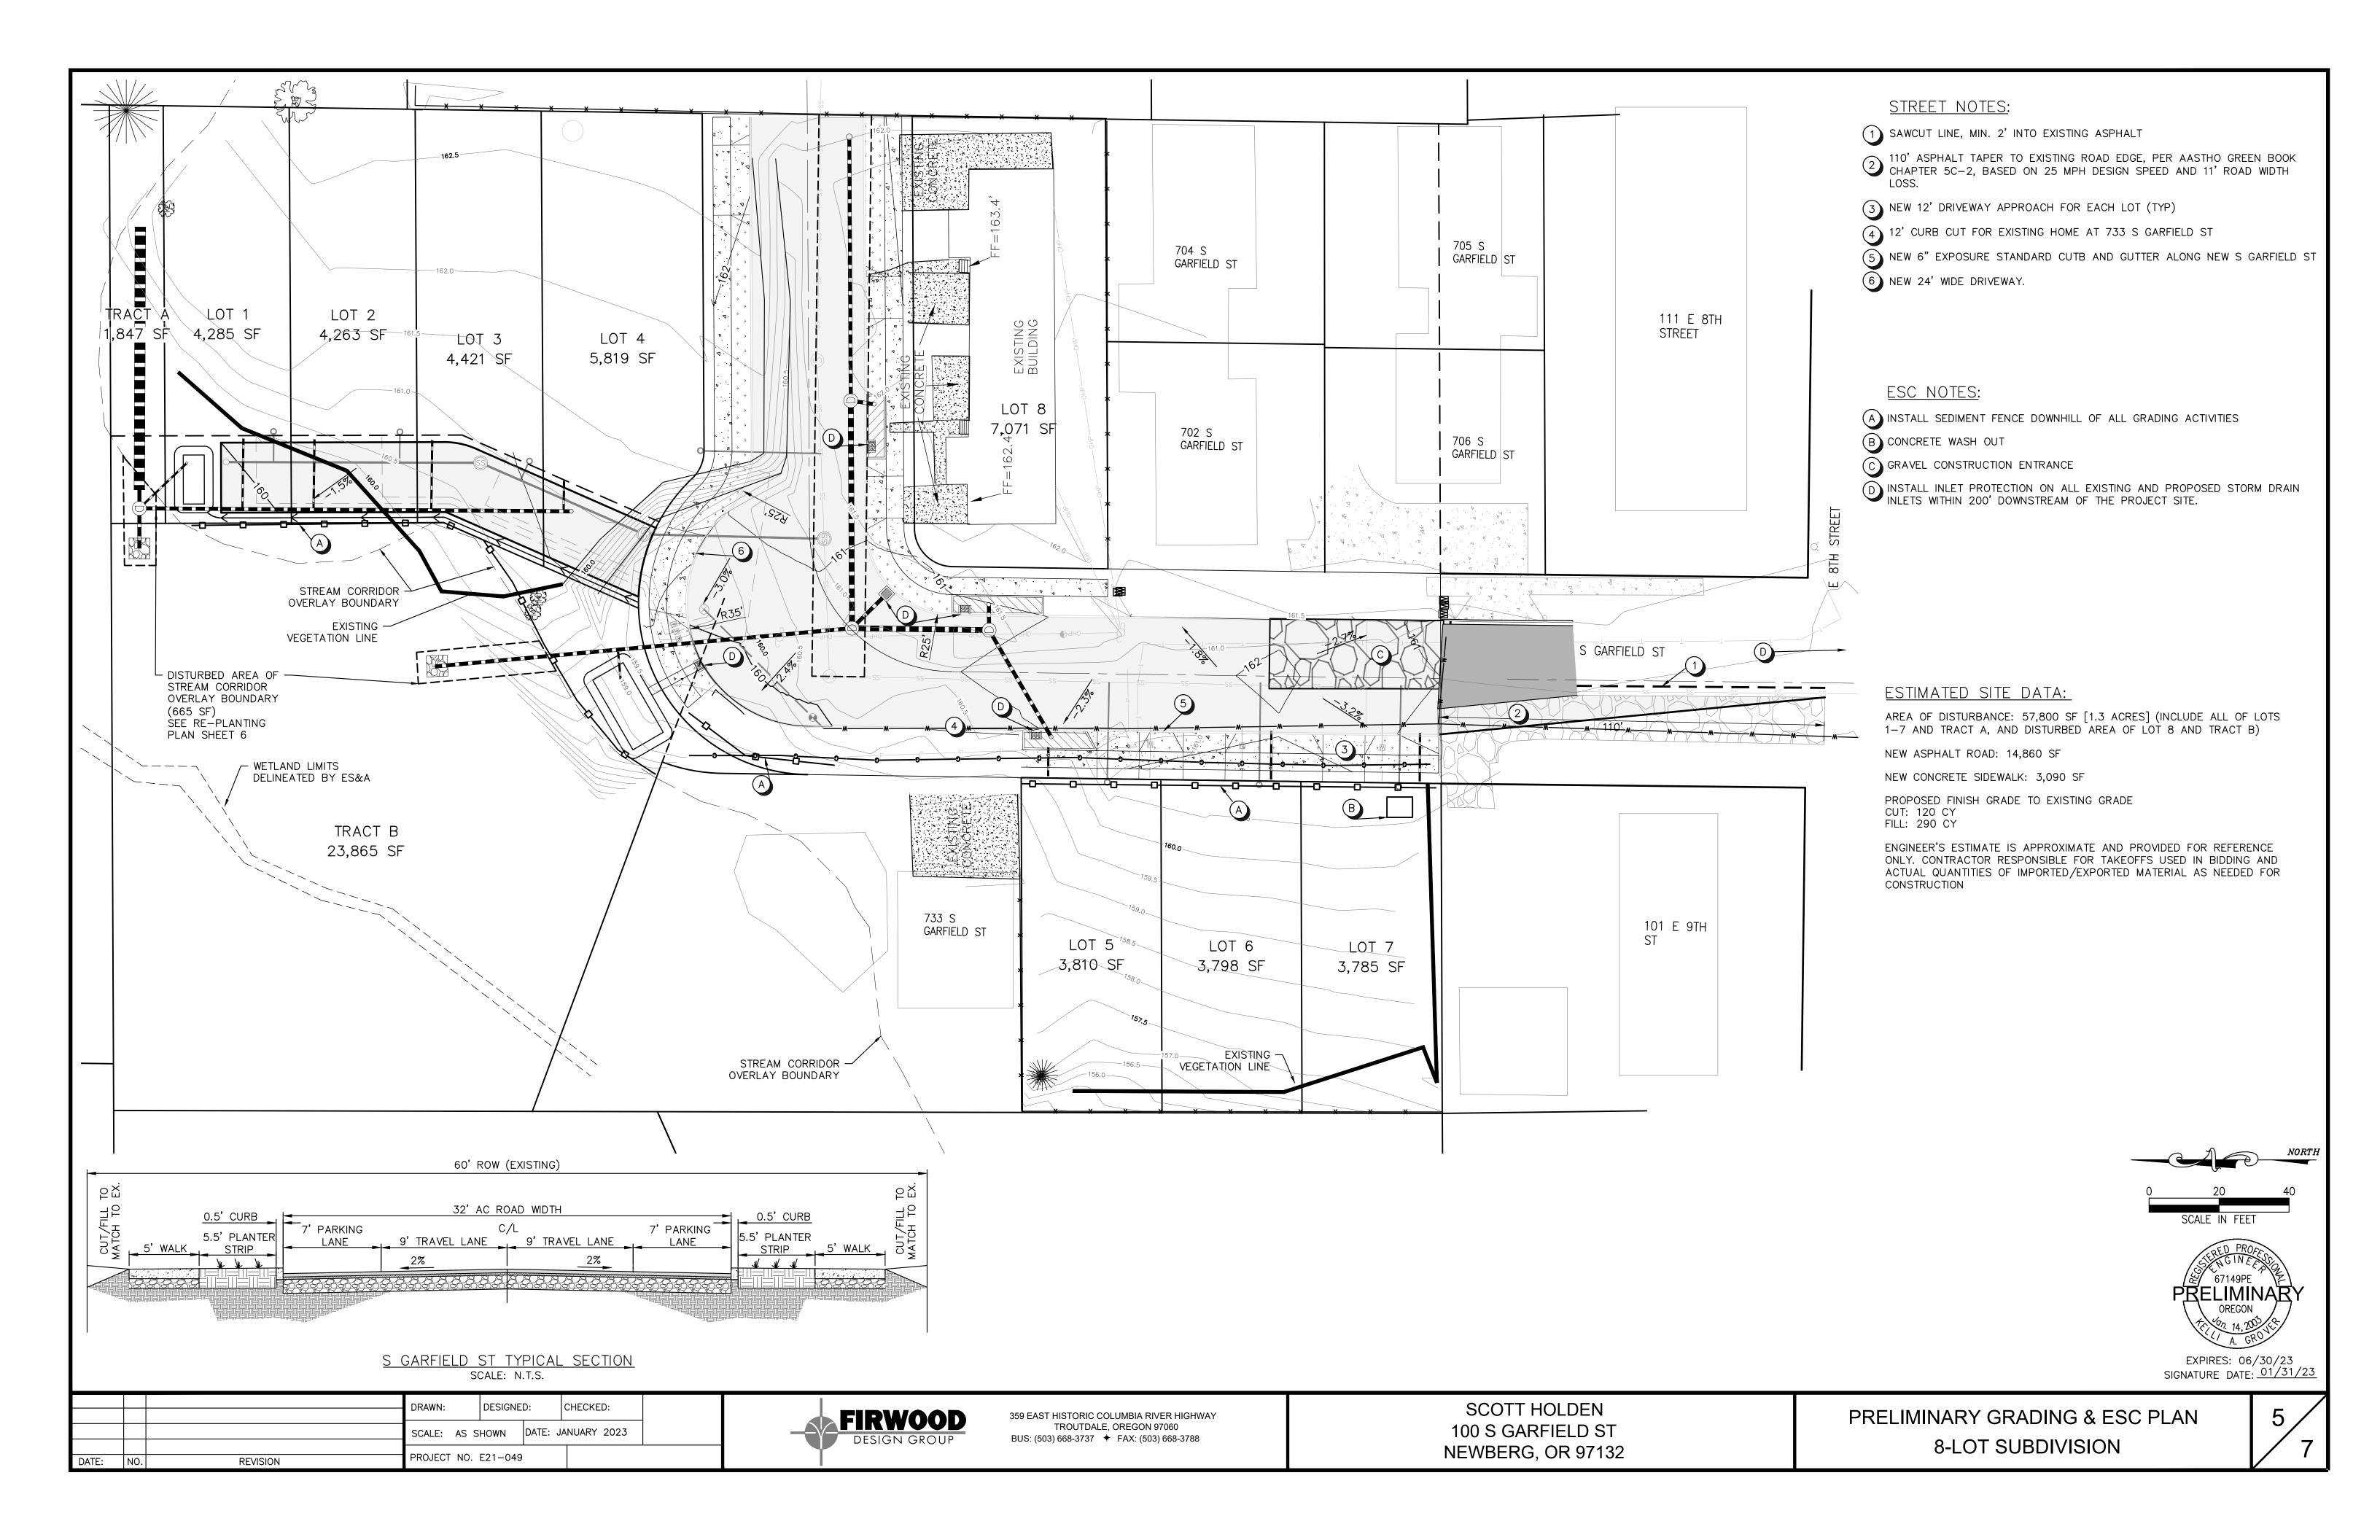

MITIGATION REPLANTING DETAIL SCALE: 1"=5'

LEGEND

TREE

LARGE SHRUB

SMALL SHRUB

GRASSES, GROUNDCOVER

MITIGATION NOTES:


- ALL DISTURBED AREAS SHALL BE REGRADED AND CONTOURED TO
- APPEAR NATURAL. ALL FILL MATERIAL SHALL BE NATIVE SOIL
- REPLANTING SHALL BE REQUIRED USING A COMBINATION OF TREES, SHRUBS AND GRASS
- AREAS TO BE REPLANTED MUST BE COMPLETED AT THE TIME OF FINAL INSPECTION OR COMPLETEION OF THE WORK
- EXISTING VEGETATION THAT CAN BE SAVED AND REPLANTED IS
- ENCOURAGED, ALTHOUGH NOT REQUIRED
- ALL DISTURBED AREAS SHALL BE REPLANTED TO ACHIEVE 90 PERCENT COVER IN ONE YEAR.
- ALL DISTURBED AREAS SHALL BE PROTECTED WITH EROSION CONTROL DEVICES PRIOR TO CONSTRUCTION ACTIVITY. THESE DEVICES SHALL REMAIN IN PLACE UNTIL 90 PERCENT COVER IS ACHIEVED.

PLANTING NOTES:

- 1. ALL PLANTS AND PLANTINGS SHALL CONFORM TO CITY OF NEWBERG STANDARDS.
- 2. CONTRACTOR IS RESPONSIBLE FOR VERIFYING PLANT QUANTITIES. IF DISCREPANCIES OCCUR, DESIGN INTENT PREVAILS OVER QUANTITIES LISTED.
- 3. SOIL PREPARATION: GROWING MEDIUM SHALL MEET CITY OF NEWBERG AND YAMHILL COUNTY STANDARDS FOR NATIVE SOIL
- 4. PLANTING SYMBOLS ARE MEANT TO CONVEY GENERAL PLANT LOCATION. PLANT COVERAGE, SPACING, AND LAYOUT SHALL BE CONSISTENT WITH THE SPACING LISTED IN THE PLANT LEGEND FOR FULL COVERAGE. ADJUST AS NECESSARY TO AVOID CONFLICTS WITH UTILITIES, LIGHTS, EXISTING VEGETATION, ETC.

PLANTING SCHEDULE

TYPE	QTY	BOTANICAL NAME	COMMON NAME	SIZE/HEIGHT	SPACING/WIDTH
	1	RHAMNUS PURHSIANA	CASCARA	30'	20'
	4	AMELANCHIER ALNIFOLIA	WESTERN SERVICEBERRY	6'	10'
	3	SAMBUCUS RACEMOSA	RED ELDERBERRY	8'	6'
	7	SYMPHORICARPOS ALBUS	COMMON SNOWBERRY	3'	2'
\bigotimes	7	RIBES LOBBI	GUMMY GOOSEBERRY	4'	4'
, ,	6	ROSA GYMNOCARPA	BALDHIP ROSE	5'	2'
	AS	JUNCUS ENSIFOLIUS	DAGGER-LEAF RUSH	1'	1'
	NECESSARY	ATHYRIUM FILIX-FEMINA	LADY FERN	4'	2'

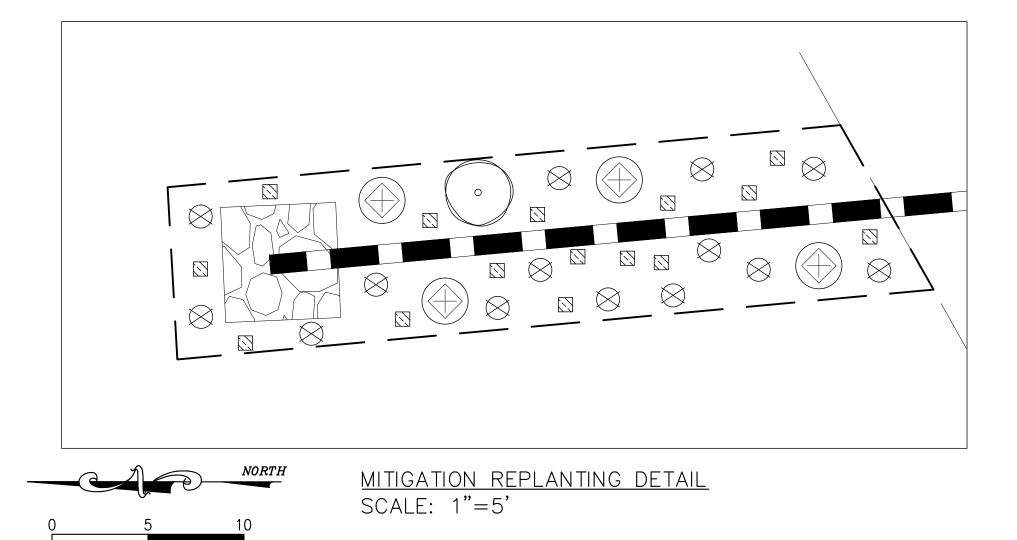

DRAWN: DESIGNED: CHECKED: SCALE: AS SHOWN DATE: JANUARY 2023 PROJECT NO. E21-049 REVISION



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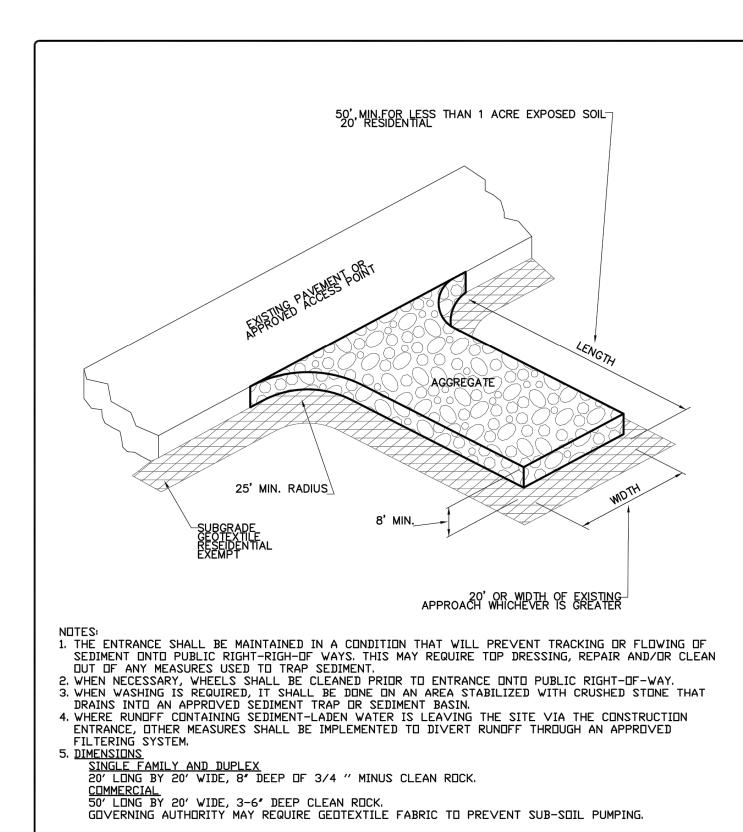
SCOTT HOLDEN 100 S GARFIELD ST NEWBERG, OR 97132

MITIGATION & RE-PLANTING PLAN **8-LOT SUBDIVISION**


EXPIRES: 06/30/23 SIGNATURE DATE: 01/31/23


<u>CITY OF NEWBERG EROSION CONTROL GENERAL NOTES</u>


- 1. THE IMPLEMENTATION OF THIS ESC PLAN AND THE CONSTRUCTION, MAINTENANCE, REPLACEMENT, AND UPGRADING OF THE ESC FACILITIES IS THE RESPONSIBILITY OF THE APPLICANT/CONTRACTOR UNTIL ALL CONSTRUCTION IS COMPLETED, APPROVED AND VEGETATION/LANDSCAPING IS ESTABLISHED.
- 2. THE ESC PLAN, ANY REVISIONS, AND INSPECTION LOGS SHALL BE KEPT ONSITE AT ALL TIMES.
- 3. THE ESC MEASURES SHOWN ON THE PLAN ARE THE MINIMUM REQUIREMENTS FOR THE PROJECT SITE AND SHALL BE UPGRADED AS NEEDED TO MAINTAIN COMPLIANCE WITH ALL REGULATIONS.
- 4. ALL ESC MEASURES SHALL BE APPROVED, IN PLACE, AND FUNCTIONAL PRIOR TO ANY GROUND DISTURBANCE OF THE SITE. CONTRACTOR SHALL MAINTAIN ALL ESC MEASURES THROUGHOUT CONSTRUCTION.
- 5. CLEARING LIMITS, CRITICAL RIPARIAN AREAS, BUFFER ZONES, AND PRESERVED VEGETATION (INCLUDING IMPORTANT TREES AND ASSOCIATED CRITICAL ROOT ZONES) SHALL HAVE HIGH VISIBILITY FENCE INSTALLED BEFORE GRADING OR CONSTRUCTION TO IDENTIFY, MARK, AND PROTECT THE AREAS.
- 6. CONSTRUCTION ACTIVITIES WILL AVOID OR MINIMIZE ANY EXCAVATION OR OTHER SOIL DESTABILIZATION FROM OCTOBER 1ST TO MAY 31ST OF THE FOLLOWING YEAR.
- 7. TEMPORARY SITE STABILIZATION MEASURES WILL BE INSTALLED AT THE END OF THE SHIFT BEFORE A HOLIDAY OR WEEKEND OR AT THE END OF EACH WORKDAY IF RAIN IS FORECAST IN THE NEXT 24 HOURS.
- 8. SEDIMENT CONTROLS MUST BE INSTALLED AND MAINTAINED ALONG THE SITE PERIMETER ON ALL DOWN-GRADIENT SIDES OF THE CONSTRUCTION SITE AND AT ALL ACTIVE AND OPERATIONAL INTERNAL STORMDRAINS AT ALL TIMES DURING CONSTRUCTION.
- 9. DRY METHODS MUST BE USED TO REMOVE SEDIMENT AND CONCRETE SWEEPINGS FROM AREAS WHERE DISCHARGE IS LIKELY TO THE STORM DRAINS, STREETS, WATERCOURSES, OR SENSITIVE AREAS
- 10. ALL DIRT AND DEBRIS TRACKED ONTO STREETS MUST BE REMOVED IMMEDIATELY IF IT CAN BE SPREAD BY TRAFFIC OR OTHERWISE REACH STORM DRAINS, WATERCOURSES, OR SENSITIVE AREAS.
- 11. SEDIMENT DISCHARGED OFFSITE MUST BE PLACED BACK ONSITE WITHIN 24 HOURS AND STABILIZED. IN-STREAM WORK SHALL BE PERFORMED IN ACCORDANCE WITH THE PROCEDURES AND TIMEFRAMES OF THE OREGON DEPARTMENT OF STATE LANDS.
- 12. NO SEDIMENT-LADEN WATER MAY BE PUMPED, DIVERTED, OR OTHERWISE DISCHARGED OFFSITE UNLESS APPROVED BY THE ESC PLAN.
- 13. SEDIMENT MUST BE REMOVED WHEN IT HAS REACHED THE LEVEL SPECIFIED IN THE STANDARD DETAIL.
- 14. SEDIMENT MUST BE REMOVED FROM SUMPED STRUCTURES WHEN THE SEDIMENT RETENTION CAPACITY HAS BEEN REDUCED BY 1/3RD AND WITHIN 30 DAYS OF PROJECT COMPLETION.
- 15. WHEN REMOVING SATURATED SOILS FROM THE SITE, EITHER WATERTIGHT TRUCKS MUST BE USED OR LOADS MUST BE DRAINED ONSITE UNTIL DRIPPING HAS BEEN REDUCED TO MINIMIZE SPILLAGE.
- 16. EROSION CONTROL MEASURES WILL BE INSPECTED ON ACTIVE SITES AT LEAST WEEKLY OR AFTER PRECIPITATION IN EXCESS OF 0.5 INCHES IN 24 HOURS. IF A SITE WILL BE INACTIVE MORE THANFOURTEEN (14) DAYS, EROSION CONTROL MEASURES WILL BE INSPECTED PRIOR TO THE INACTIVE PERIOD AND EVERY TWO (2) WEEKS DURING THE INACTIVE PERIOD.
- 17. ALL CONSTRUCTION SITES MUST FOLLOW PROPER STORAGE, APPLICATION, AND DISPOSAL PROCEDURES OF CONSTRUCTION MATERIALS. NO DUMPING OR DISPOSAL OF CONSTRUCTION DEBRIS, WASTE, OR SPOIL MATERIAL WILL OCCUR IN ANY STREAM, STORMWATER SYSTEM, WETLANDS, SURFACE WATERS, OR OTHER WATERCOURSES OR SENSITIVE AREAS.
- 18. WRITTEN SPILL PREVENTION AND RESPONSE PROCEDURES ARE REQUIRED FOR ALL SITES.
- 19. TOXIC AND HAZARDOUS MATERIALS MUST HAVE COVER AND SECONDARY CONTAINMENT.
- 20. CONCRETE TRUCKS SHALL NOT DISCHARGE WASHWATER WHERE IT IS LIKELY TO FLOW INTO STORM DRAINS, STREETS, WATERCOURSES, OR SENSITIVE AREAS.
- 21. PAVING ACTIVITIES SHALL BE MINIMIZED BETWEEN OCTOBER 1ST AND MAY 31ST OF THE FOLLOWING YEAR TO AVOID POTENTIAL DISCHARGE OF PAVING CHEMICALS INTO THE STORM DRAINS, STREETS, WATERCOURSES, OR SENSITIVE AREAS.
- 22. ALL ESC MEASURES SHALL BE REMOVED FROM THE SITE 30 DAYS AFTER CONSTRUCTION IS COMPLETED AND APPROVED BY THE CITY.




PUBLIC WORKS ENGINEERING DIVISION 414 E. FIRST STREET NEWBERG, DR 97132 PHONE 503-537-1240 REVISIONS: CONSTRUCTION ENTRANCE SCALE: N.T.S DATE: May 2007 APPROVED D. Danicic STANDARD DRAWING 601					
PUBLIC WORKS ENGINEERING DIVISION 414 E. FIRST STREET NEWBERG, DR 97132 DATE: May 2007 APPROVED BY: D. Danicle STANDARD 601	City of Co.	REVISIONS:		SCALE:	N.T.S
PUBLIC WORKS ENGINEERING DIVISION 414 E. FIRST STREET NEWBERG, OR 97132 ENTRANCE BY: BY: D. Danicic STANDARD 601	-Nowhord		CONSTRUCTION	DATE:	May 2007
414 E. FIRST STREET NEWBERG, DR 97132 STANDARD SOLD	rac anner 2 🛬				D. Danicic
FAX: 503-537-1277	114 E. FIRST STREET NEWBERG, DR 97132 PHONE: 503-537-1240			STANDARD DRAWING	601

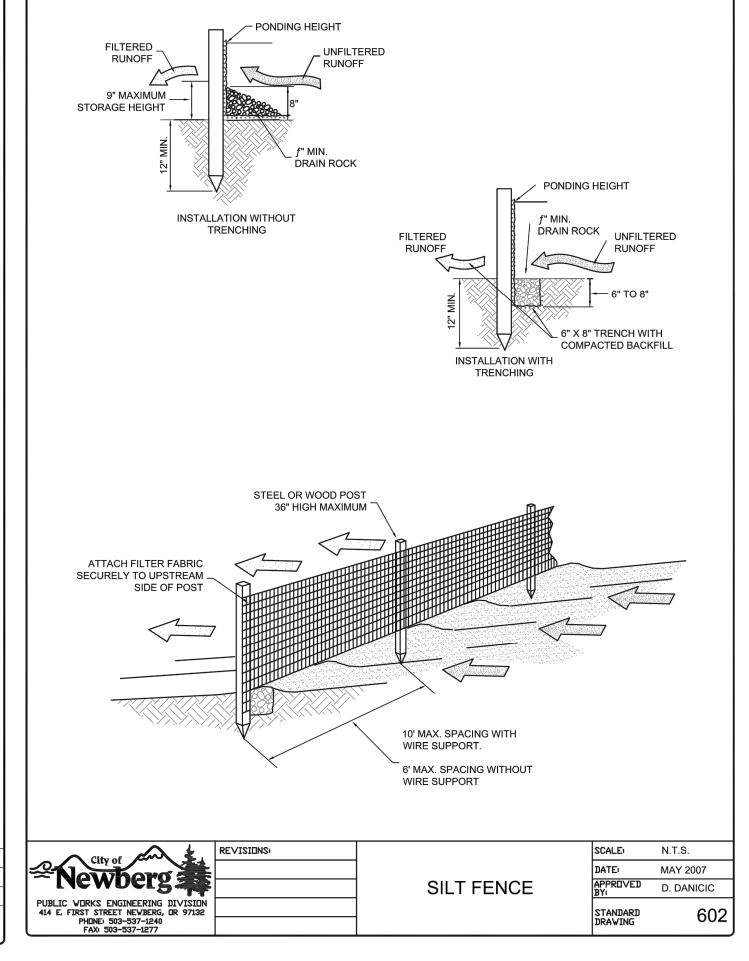

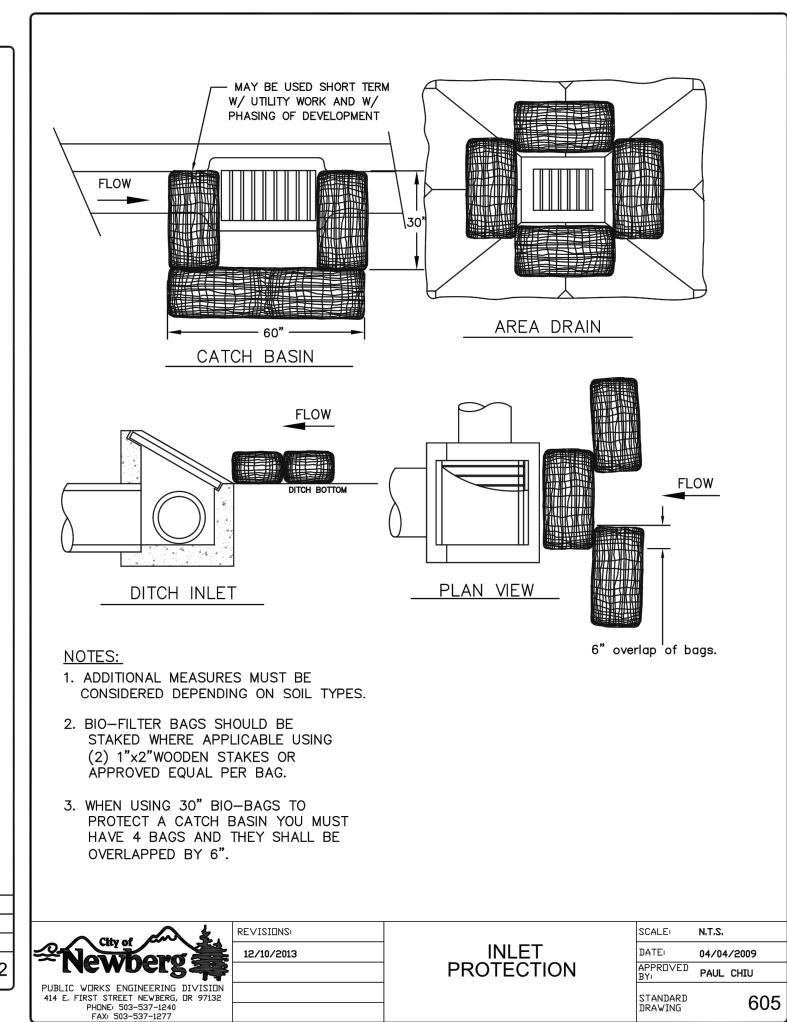

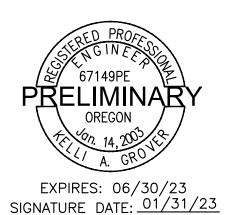

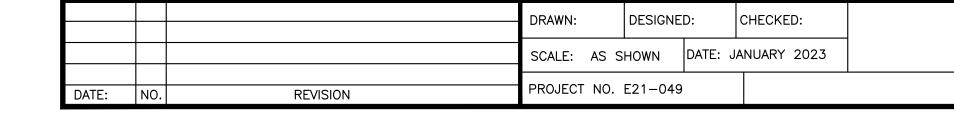



359 EAST HISTORIC COLUMBIA RIVER HIGHWAY
TROUTDALE, OREGON 97060
BUS: (503) 668-3737 ★ FAX: (503) 668-3788

SCOTT HOLDEN 100 S GARFIELD ST NEWBERG, OR 97132 ESC DETAILS & NOTES 8-LOT SUBDIVISION