

FRIENDSVIEW UNIVERSITY VILLAGE PHASE 2

1001 FULTON STREET NEWBERG OREGON

100% DESIGN DEVELOPMENT SET

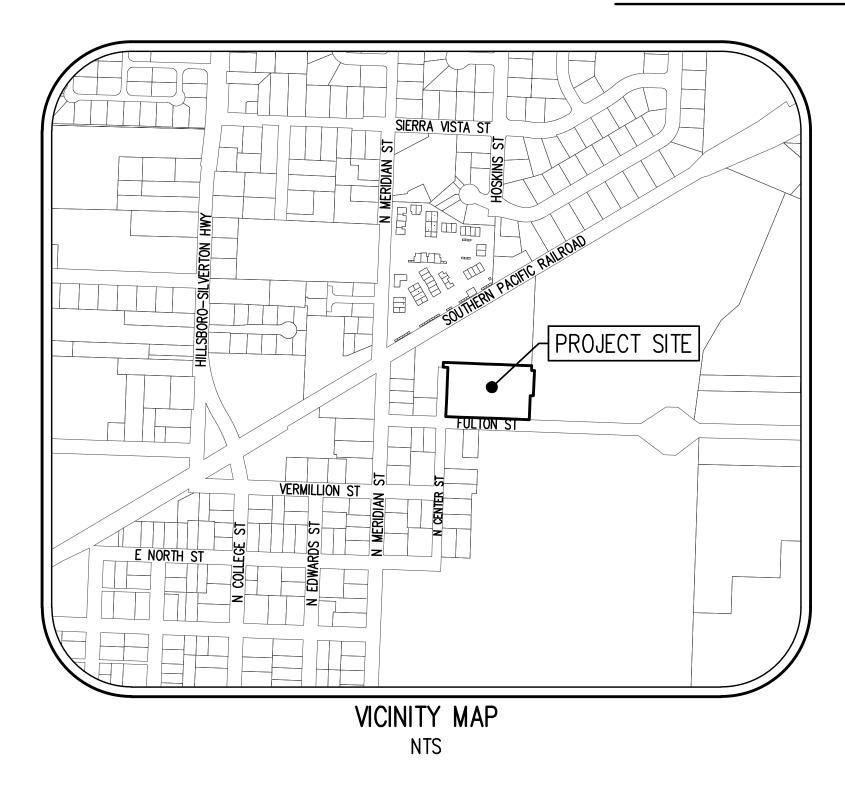

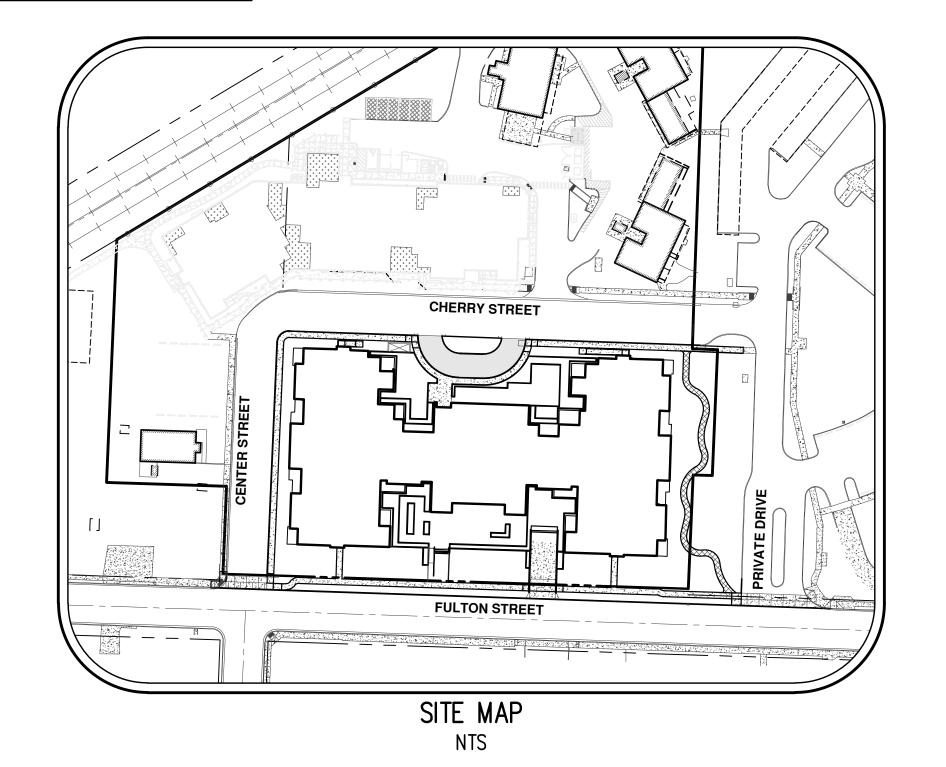

<u>E</u>	EXISTING	PROPOSED		EXISTING	PROPOSED
DECIDUOUS TREE	\bigcirc	\bigcirc	STORM SEWER CLEAN OUT	0	<u> </u>
			STORM SEWER CATCH BASIN		
CONIFEROUS TREE	7×		STORM SEWER AREA DRAIN		
FIRE HYDRANT	Д		STORM SEWER MANHOLE		
VATER BLOWOFF	Ŷ	†	GAS METER	O	
VATER METER		-	GAS VALVE	Ø	10 1
VATER VALVE	M	H	GUY WIRE ANCHOR	\leftarrow	\leftarrow
OUBLE CHECK VALVE	\boxtimes	₽	POWER POLE	-0-	-
AIR RELEASE VALVE	රු	7	POWER VAULT	P	Р
SANITARY SEWER CLEAN OU	T O	•	POWER JUNCTION BOX		Δ
SANITARY SEWER MANHOLE	0	•	POWER PEDESTAL		
SIGN	- o-	<u> </u>	COMMUNICATIONS VAULT COMMUNICATIONS JUNCTION BOX	C	C
STREET LIGHT MAILBOX	ф [MB]	ф [MB]	COMMUNICATIONS RISER	\triangle	A
RIGHT-OF-WAY LINE		<u>EXISTING</u>		<u>PROPOSED</u>	· – –
	<u> </u>				
BOUNDARY LINE	•				
PROPERTY LINE					
CENTERLINE			_ _		
DITCH					
CURB					
EDGE OF PAVEMENT			— — 		
EASEMENT					
FENCE LINE		· · · · · ·	· · · · · · · · · · · · · · · · · · ·		
GRAVEL EDGE					•••••
POWER LINE		— PWR — -	PWR — PWR —		PWR
OVERHEAD WIRE		— — онw	OHW -		ОН W ———
COMMUNICATIONS LINE		— сом — — —	COM — COM —		сом ———
TIBER OPTIC LINE		CFO	— CFO — — — —	CFO	— сғо —
GAS LINE		— GAS — — -	— GAS — GAS —	GAS	— GAS ———
STORM SEWER LINE		— STM — — —	— — STM — — — STM —		втм ———
SANITARY SEWER LINE		SAN	— — SAN — — SAN —	;	5AN
WATER LINE		WAT	WAT WAT _		NAT

SHEET SET

GENERAL SHEETS

- C1 COVER SHEET WITH VICINITY, SITE MAP, AND LEGEND
- C2 PRELIMINARY SITE PLAN
- C3 EXISTING CONDITIONS PLAN
- C4 PRELIMINARY DEMOLITION PLAN
- C5 PRELIMINARY EROSION AND SEDIMENTATION CONTROL PLAN
- C6 PRELIMINARY GRADING PLAN
- C7 PRELIMINARY COMPOSITE UTILITY PLAN

LANDSCAPING PLANS

- L100 EXISTING TREE INVENTORY AND PROTECTION PLAN
- L300 LANDSCAPE SITE MATERIALS PLAN
- L301 NORTH COURTYARD MATERIALS PLAN ENLARGEMENT
- L302 SOUTH COURTYARD MATERIALS PLAN ENLARGEMENT
- L500 SITE PLANTING PLAN
- L501 NORTH COURTYARD PLANTING PLAN ENLARGEMENT
- L502 SOUTH COURTYARD PLANTING PLAN ENLARGEMENT
- L600 IRRIGATION PLAN
- L701 LANDSCAPE CONSTRUCTION DETAILS
- L702 PLANTING DETAILS L703 IRRIGATION DETAILS

NOTICE TO EXCAVATORS:

EXCAVATION. CALL 503-246-6699.

ARCHITECTURAL SHEETS

- BICYCLE PARKING PLANS
- BASEMENT FLOOR PLAN
- A3 LEVEL 1 FLOOR PLAN LEVELS 2-4 FLOOR PLANS
- LEVEL 5 FLOOR PLAN
- COLORED EXTERIOR ELEVATIONS COLORED EXTERIOR ELEVATIONS
- COLORED EXTERIOR ELEVATIONS
- BUILDING HEIGHT ANALYSIS AT FULTON A10 BUILDING HEIGHT ANALYSIS AT CENTER STREET
- A11 USEABLE OUTDOOR AREA
- A12 EXTERIOR MATERIALS BOARD
- A13 GARAGE ENTRY PLAN

OREGON LAW REQUIRES YOU TO FOLLOW RULES ADOPTED BY THE OREGON

952-001-0010 THROUGH OAR 952-001-0090. YOU MAY OBTAIN COPIES

OF THESE RULES FROM THE CENTER BY CALLING 503-232-1987. IF YOU

CENTER. YOU MUST NOTIFY THE CENTER AT LEAST TWO BUSINESS DAYS

BUT NOT MORE THAN TEN BUSINESS DAYS, BEFORE COMMENCING AN

UTILITY NOTIFICATION CENTER. THOSE RULES ARE SET FORTH IN OAR

HAVE ANY QUESTIONS ABOUT THE RULES, YOU MAY CONTACT THE

E1 ELECTRICAL SITE LIGHTING

ARCHITECT

MICHELLE RAE

LRS ARCHITECTS

720 NW DAVIS, SUITE 300

PORTLAND, OR 97209

P: (503) 221-1121

E: MREÁ@LRSARCHITECTS.COM

LANDSCAPING:

SHAPIRO DIDWAY LANDSCAPE ARCHITECTURE

CONTACT: NATE OTANI

1204 SE WATER AVE, SUITE 21

PORTLAND, OR 97214

P: (503) 232-0520

E: NATE@SHAPIRODIDWAY.COM

CIVIL ENGINEERING/SURVEYING/PLANNING:

AKS ENGINEERING & FORESTRY, LLC CONTACT: MIMI DOUKAS, AICP, RLA 12965 SW HERMAN ROAD, SUITE 100

TUALATIN, OR 97062

P: (503) 563-6151

E: MIMID@AKS-ENG.COM

PROPERTY DESCRIPTION

TAX LOTS 1500,1600,2600 YAMHILL COUNTY TAX MAP 3S 2W 17CB, LOCATED IN THE NORTHWEST 1/4 OF THE SOUTH WEST 1/4 OF SECTION17, TOWNSHIP 3 SOUTH, RANGE 2 WEST, WILLAMETTE MERIDIAN, CITY OF NEWBERG, YAMHILL COUNTY, OREGON.

EXISTING LAND USE

EXISTING SINGLE FAMILY RESIDENCES

PROJECT PURPOSE

CONSTRUCTION OF CONTINUING CARE FACILITY

VERTICAL DATUM

VERTICAL DATUM: ELEVATIONS ARE BASED ON CITY OF NEWBERG BENCHMARK NO. 89 WITH A NAVD 88 ELEVATION OF 202.05 FEET.



CONSULTANT:

PROJECT NUMBER:

University Village Phase II


1001 Fulton Street. Newberg OR 97132



SHEET TITLE: **COVER SHEET** WITH VICINITY, SITE MAP, AND **LEGEND**

DRAWN BY:

DATE ISSUED:

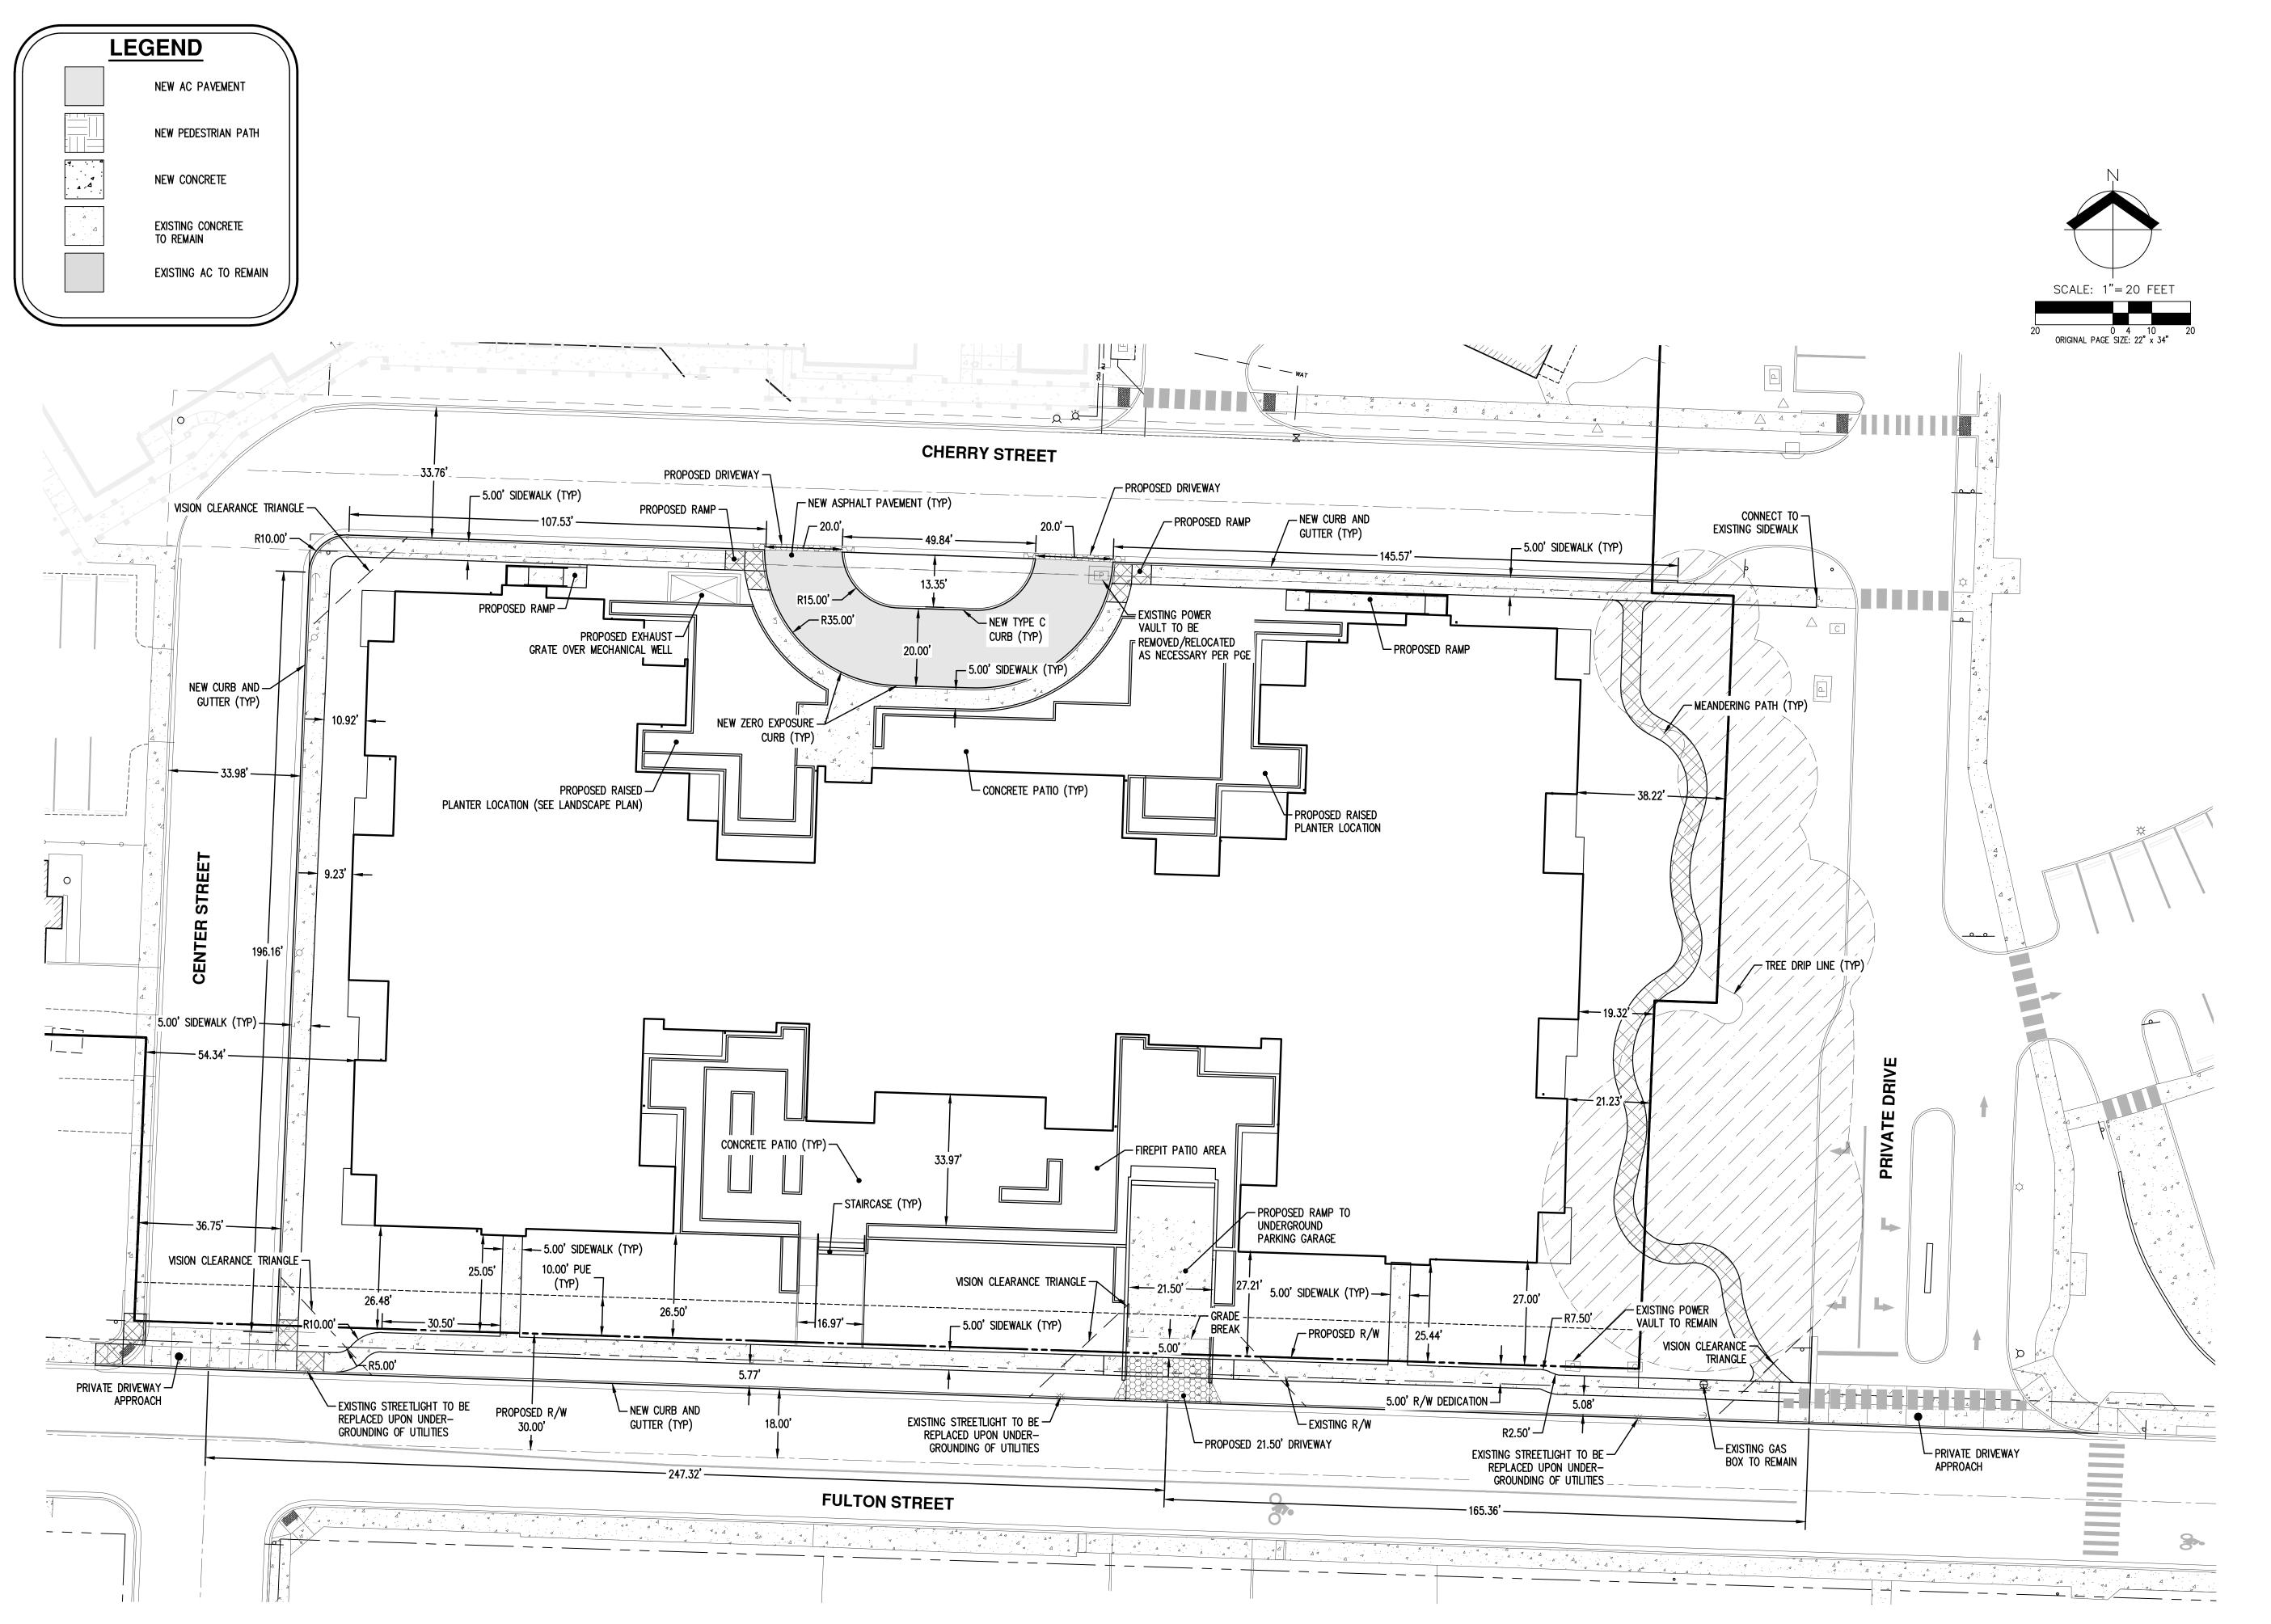

ARCHITECTS

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CONSULTANT:



PROJECT NUMBER:

University Village Phase II

217304

1001 Fulton Street, Newberg OR 97132



PRELIMINARY SITE
PLAN


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DATE ISSUED:


10/02/2020

SHEET:

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PROJECT NUMBER:

University Village Phase II 1001 Fulton Street,

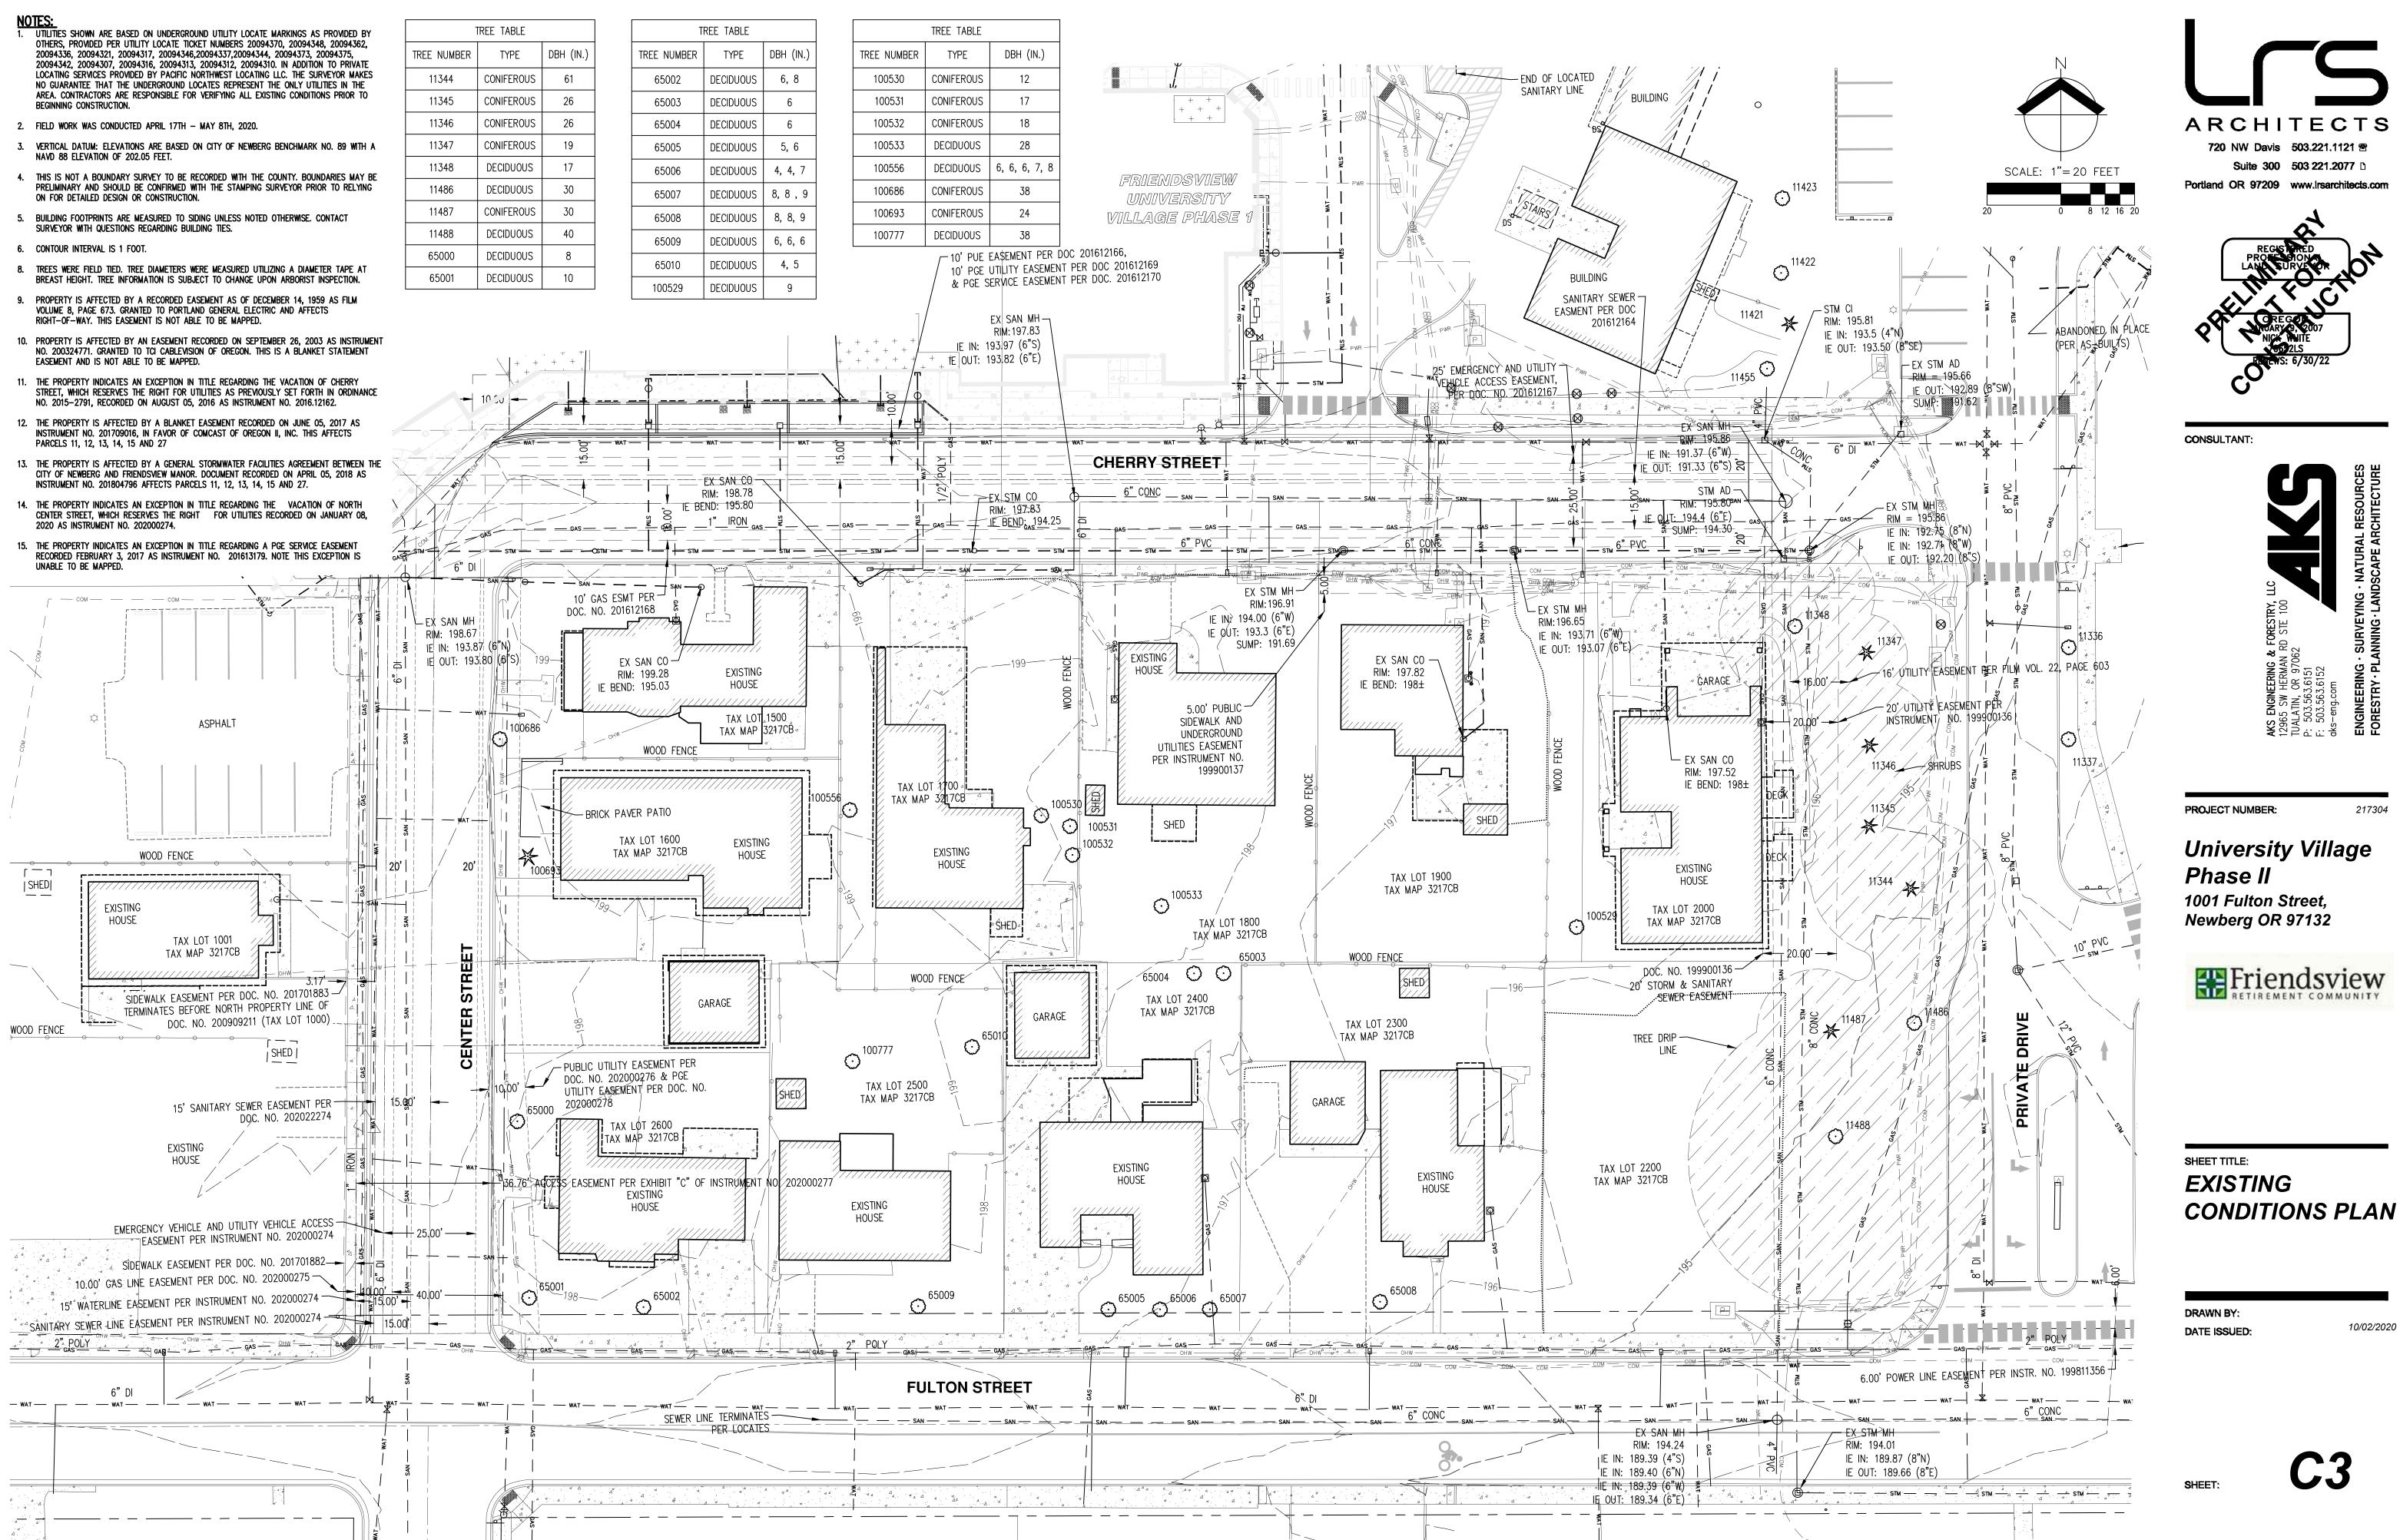
Newberg OR 97132

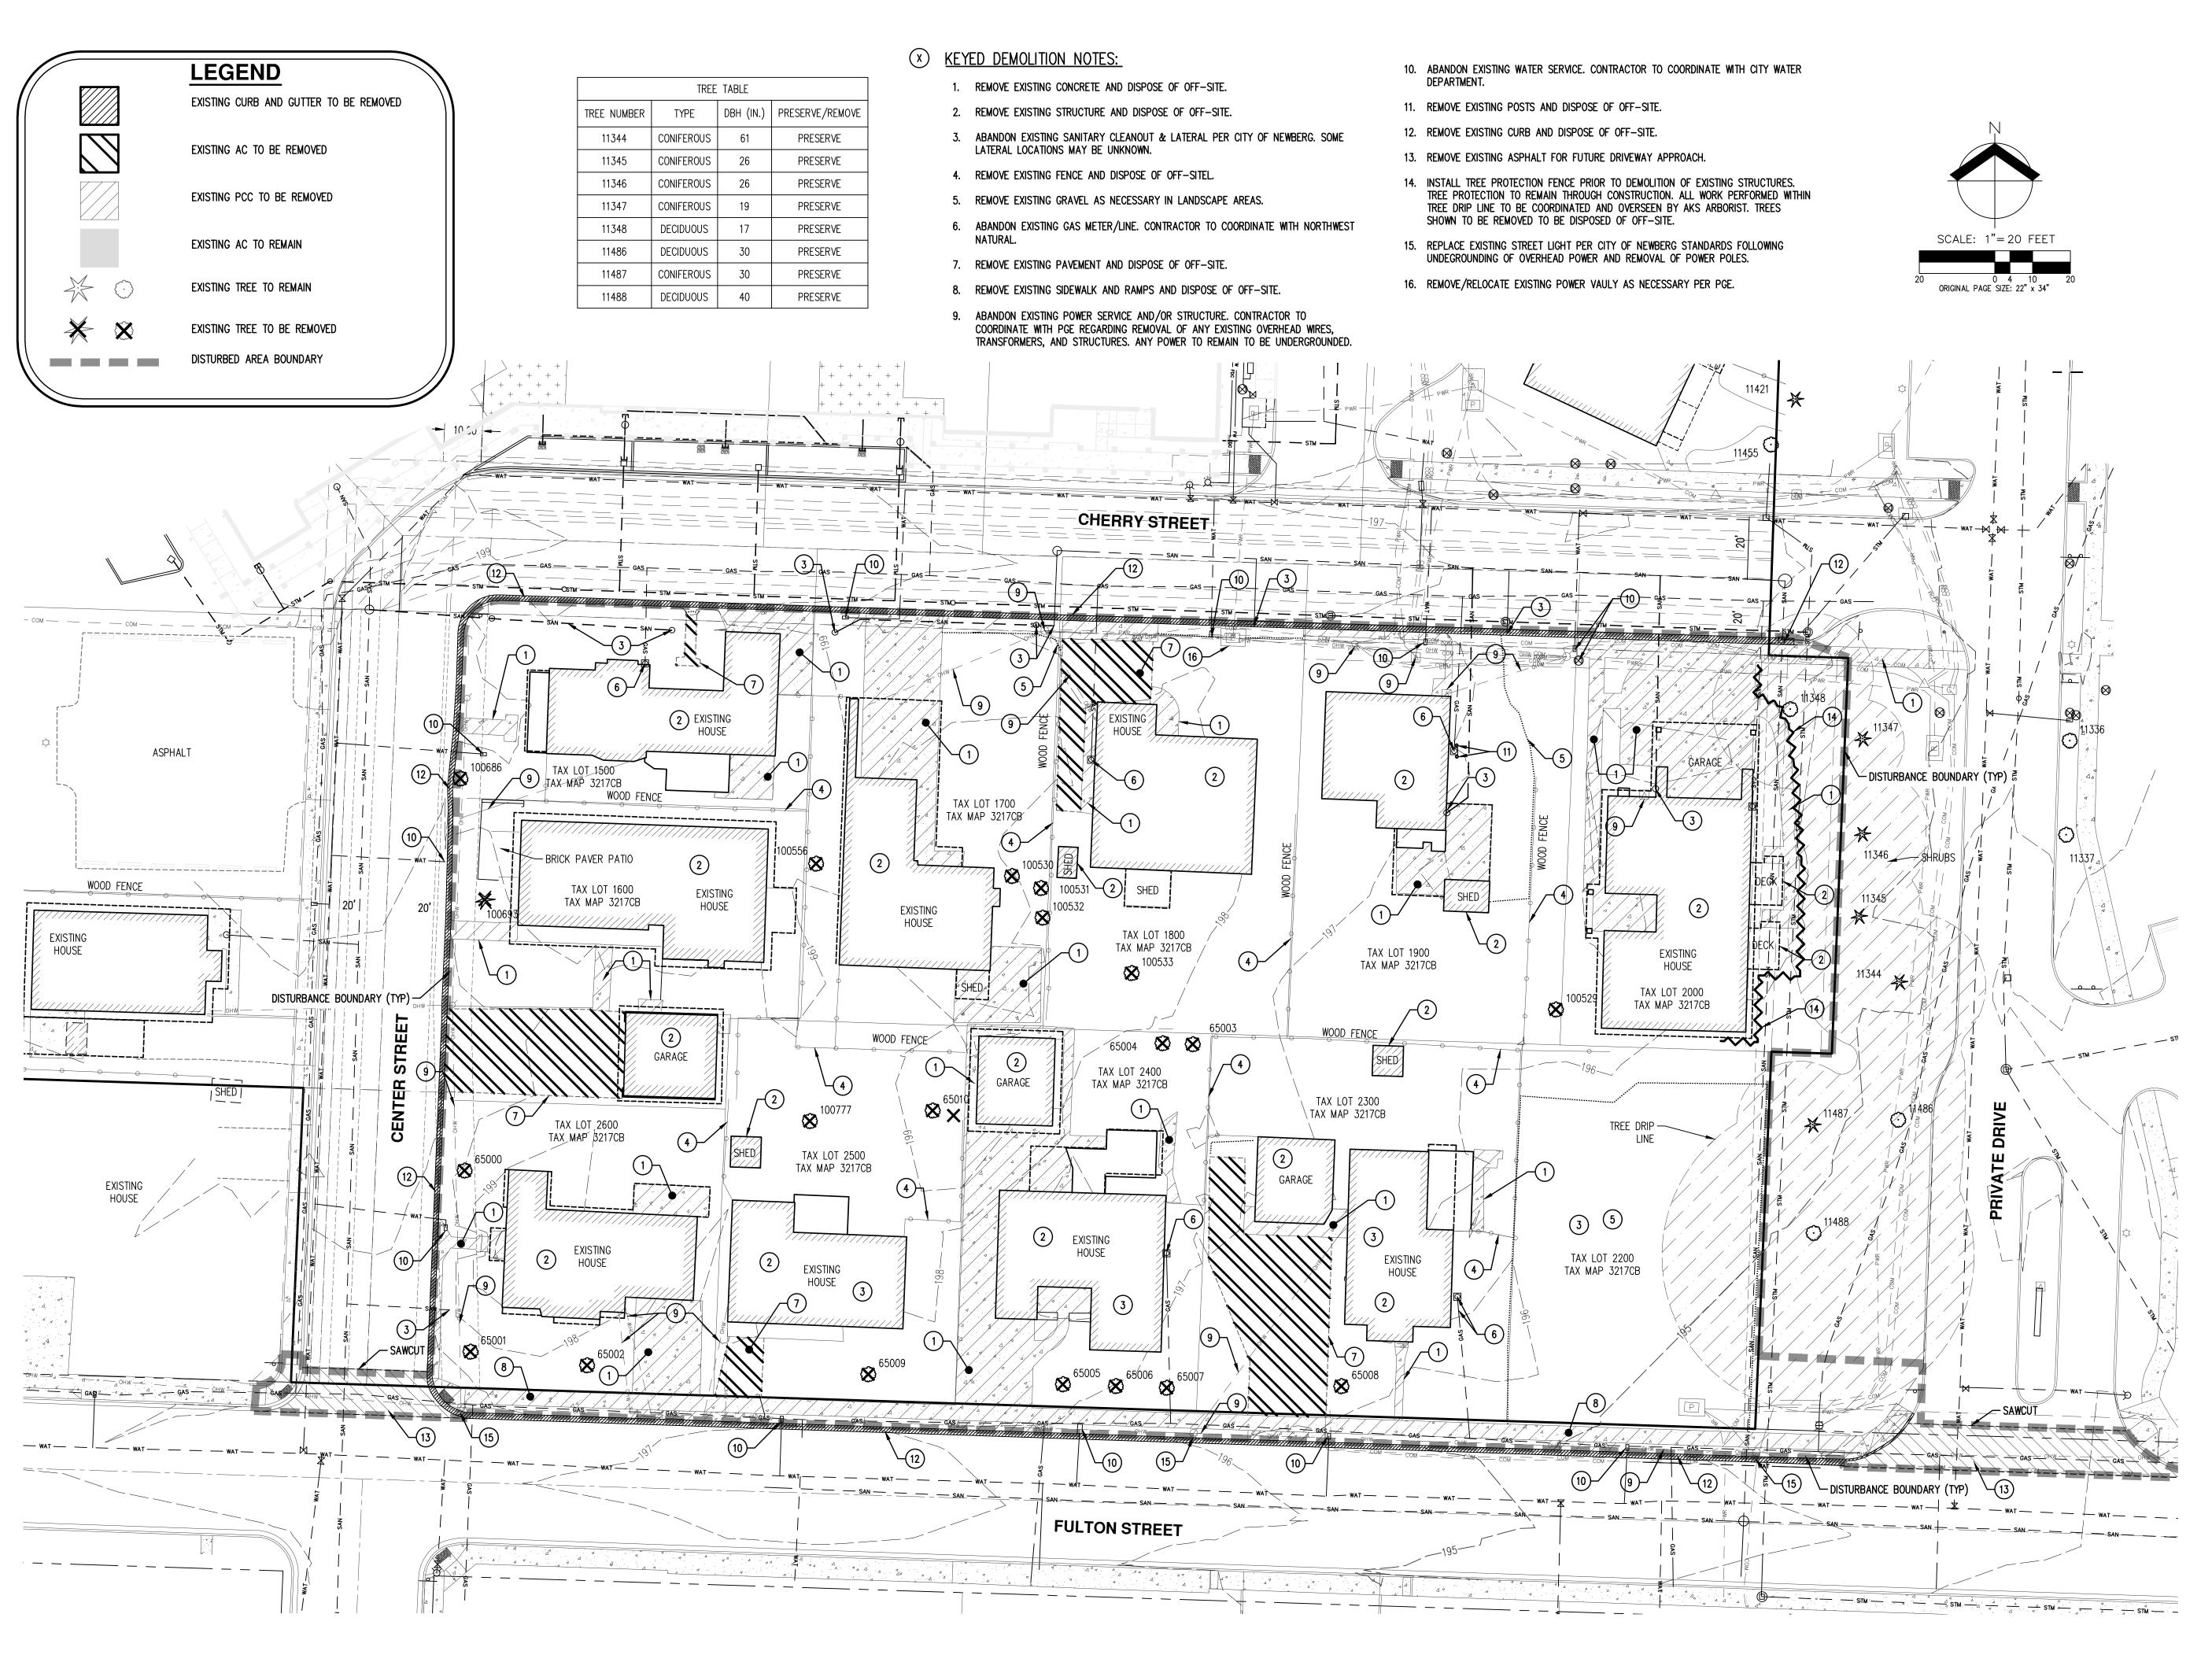Friendsview RETIREMENT COMMUNITY


SHEET TITLE: **PRELIMINARY DEMOLITION PLAN**


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DATE ISSUED:

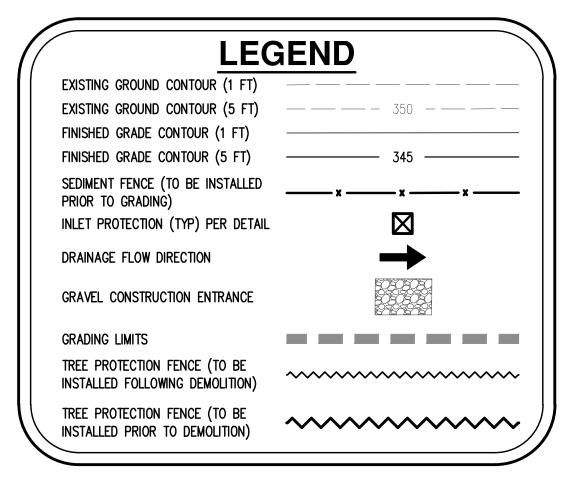

NOTE:
ALL WORK WITHIN TREE DRIP LINE TO BE COORDINATED
AND OVERSEEN BY AKS ARBORIST.



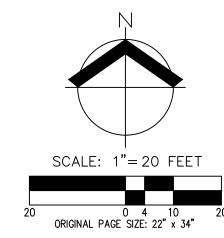

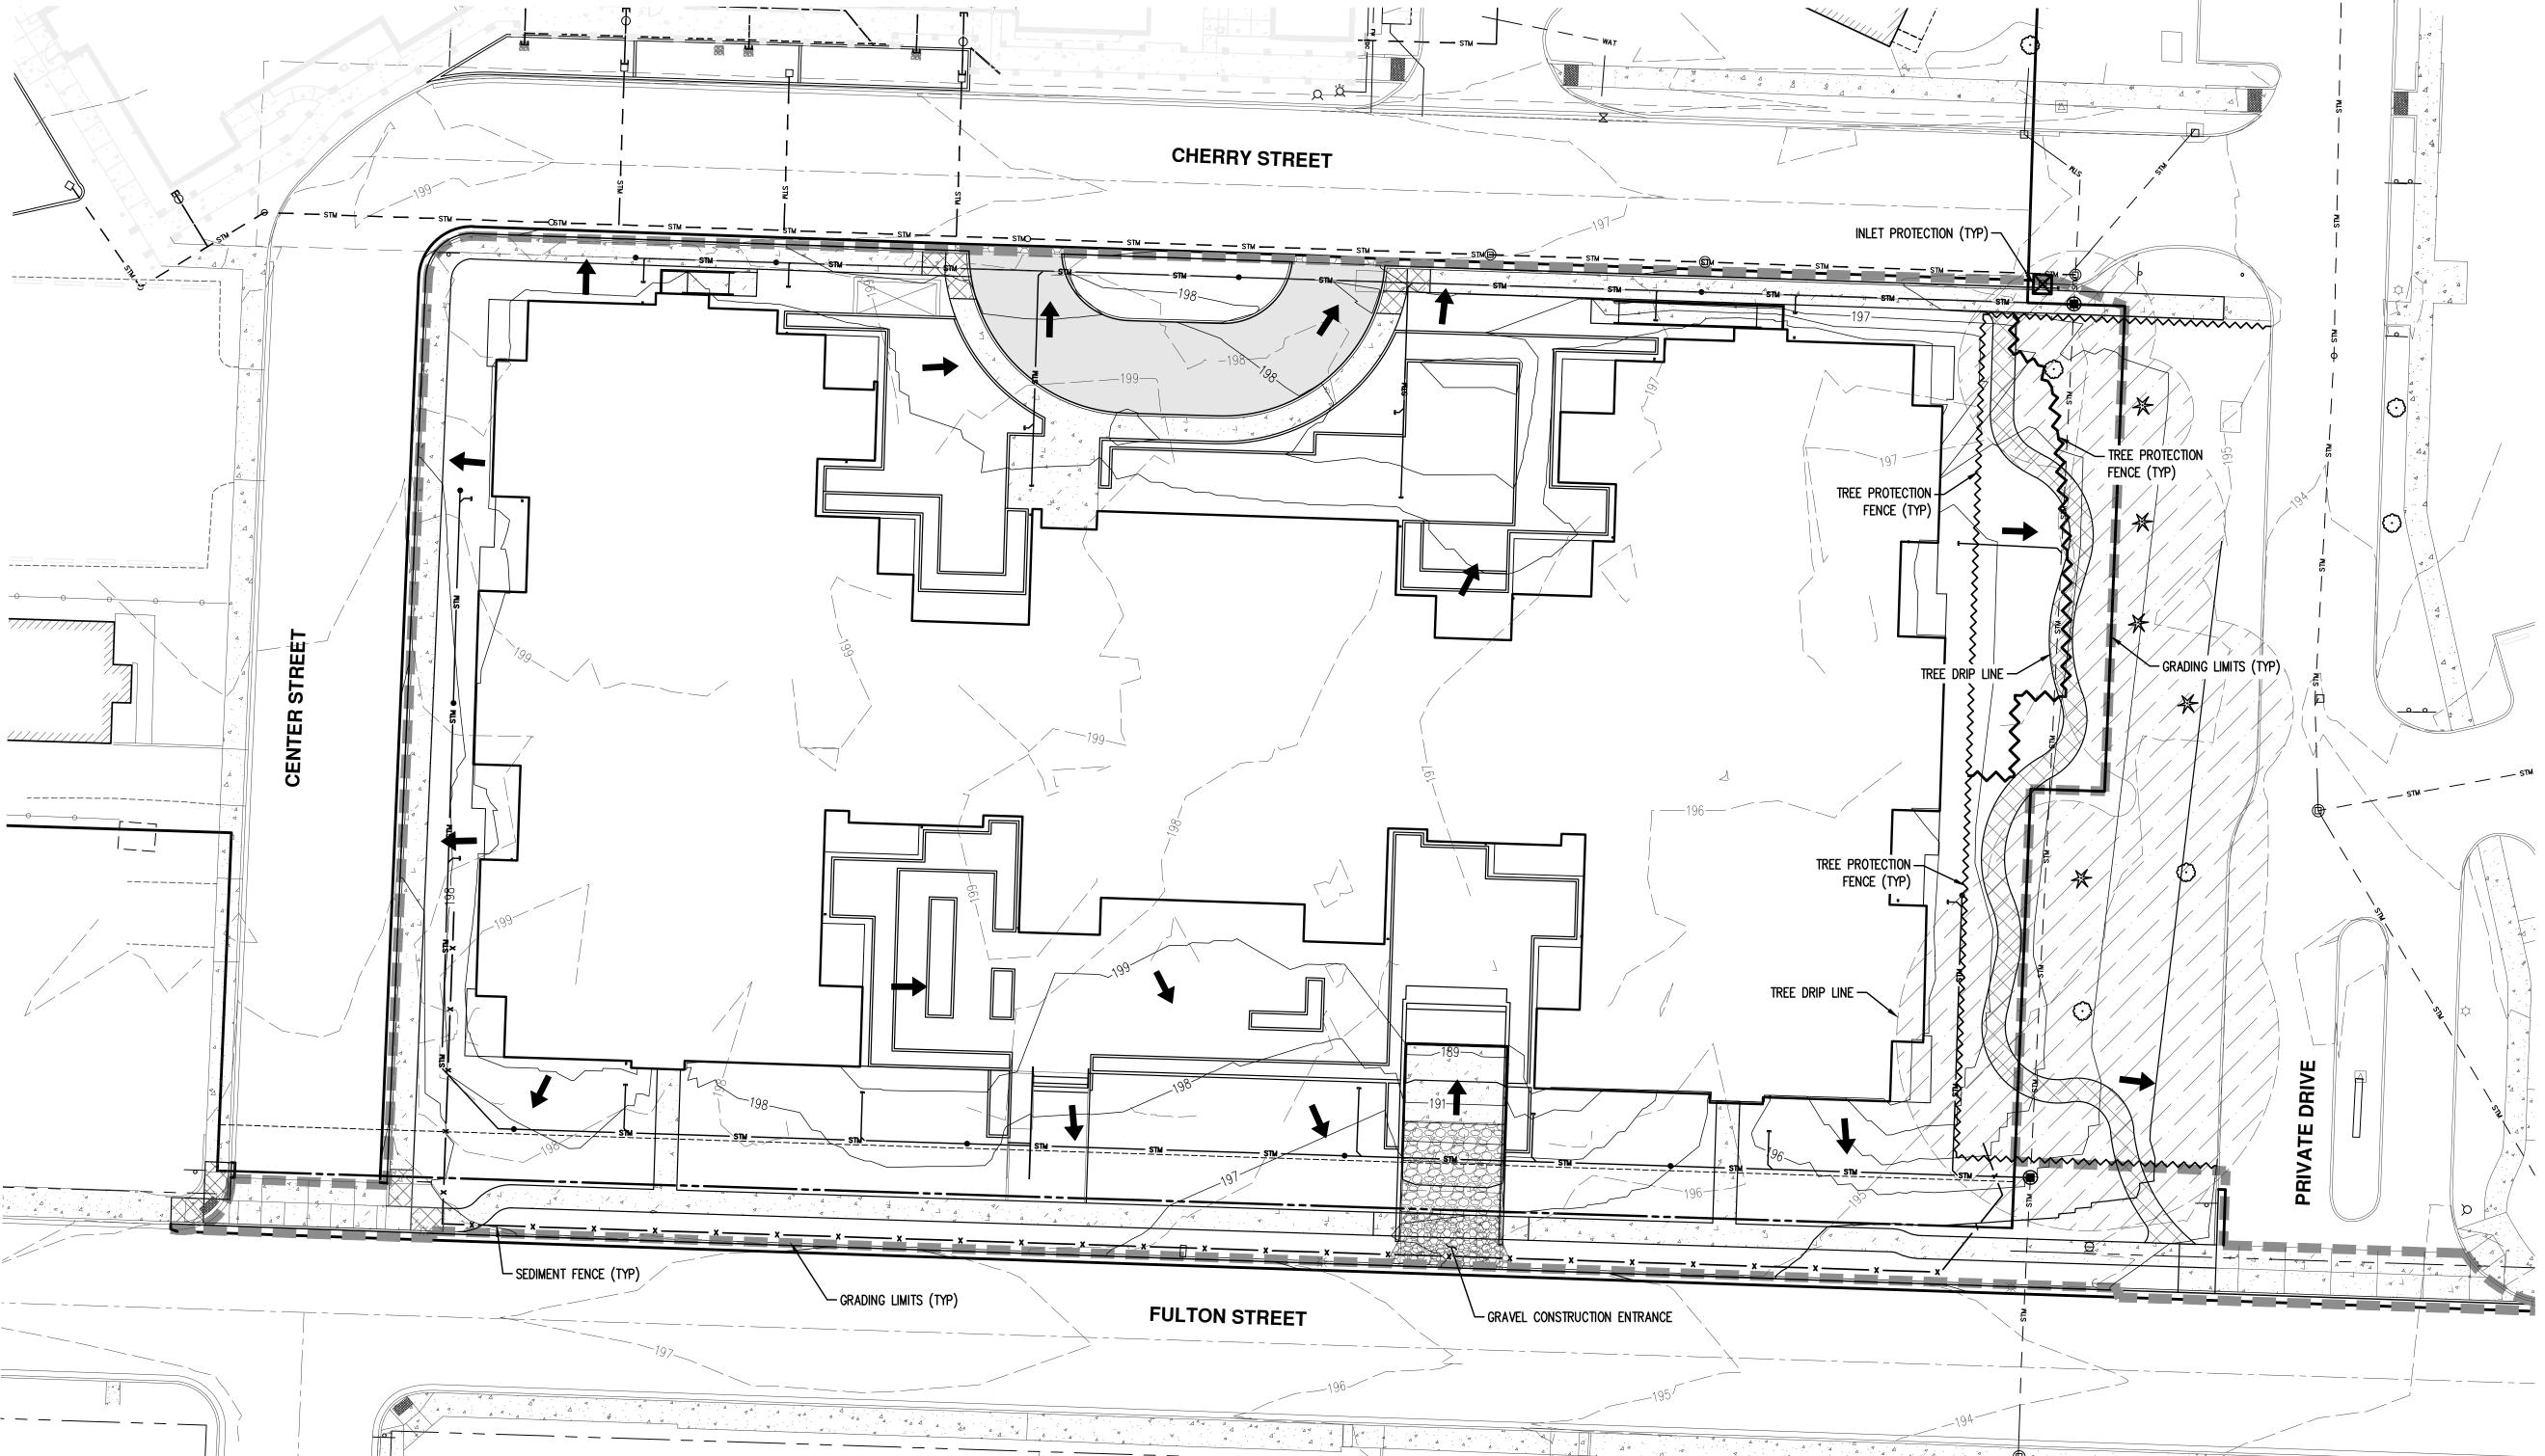

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CONSULTANT:



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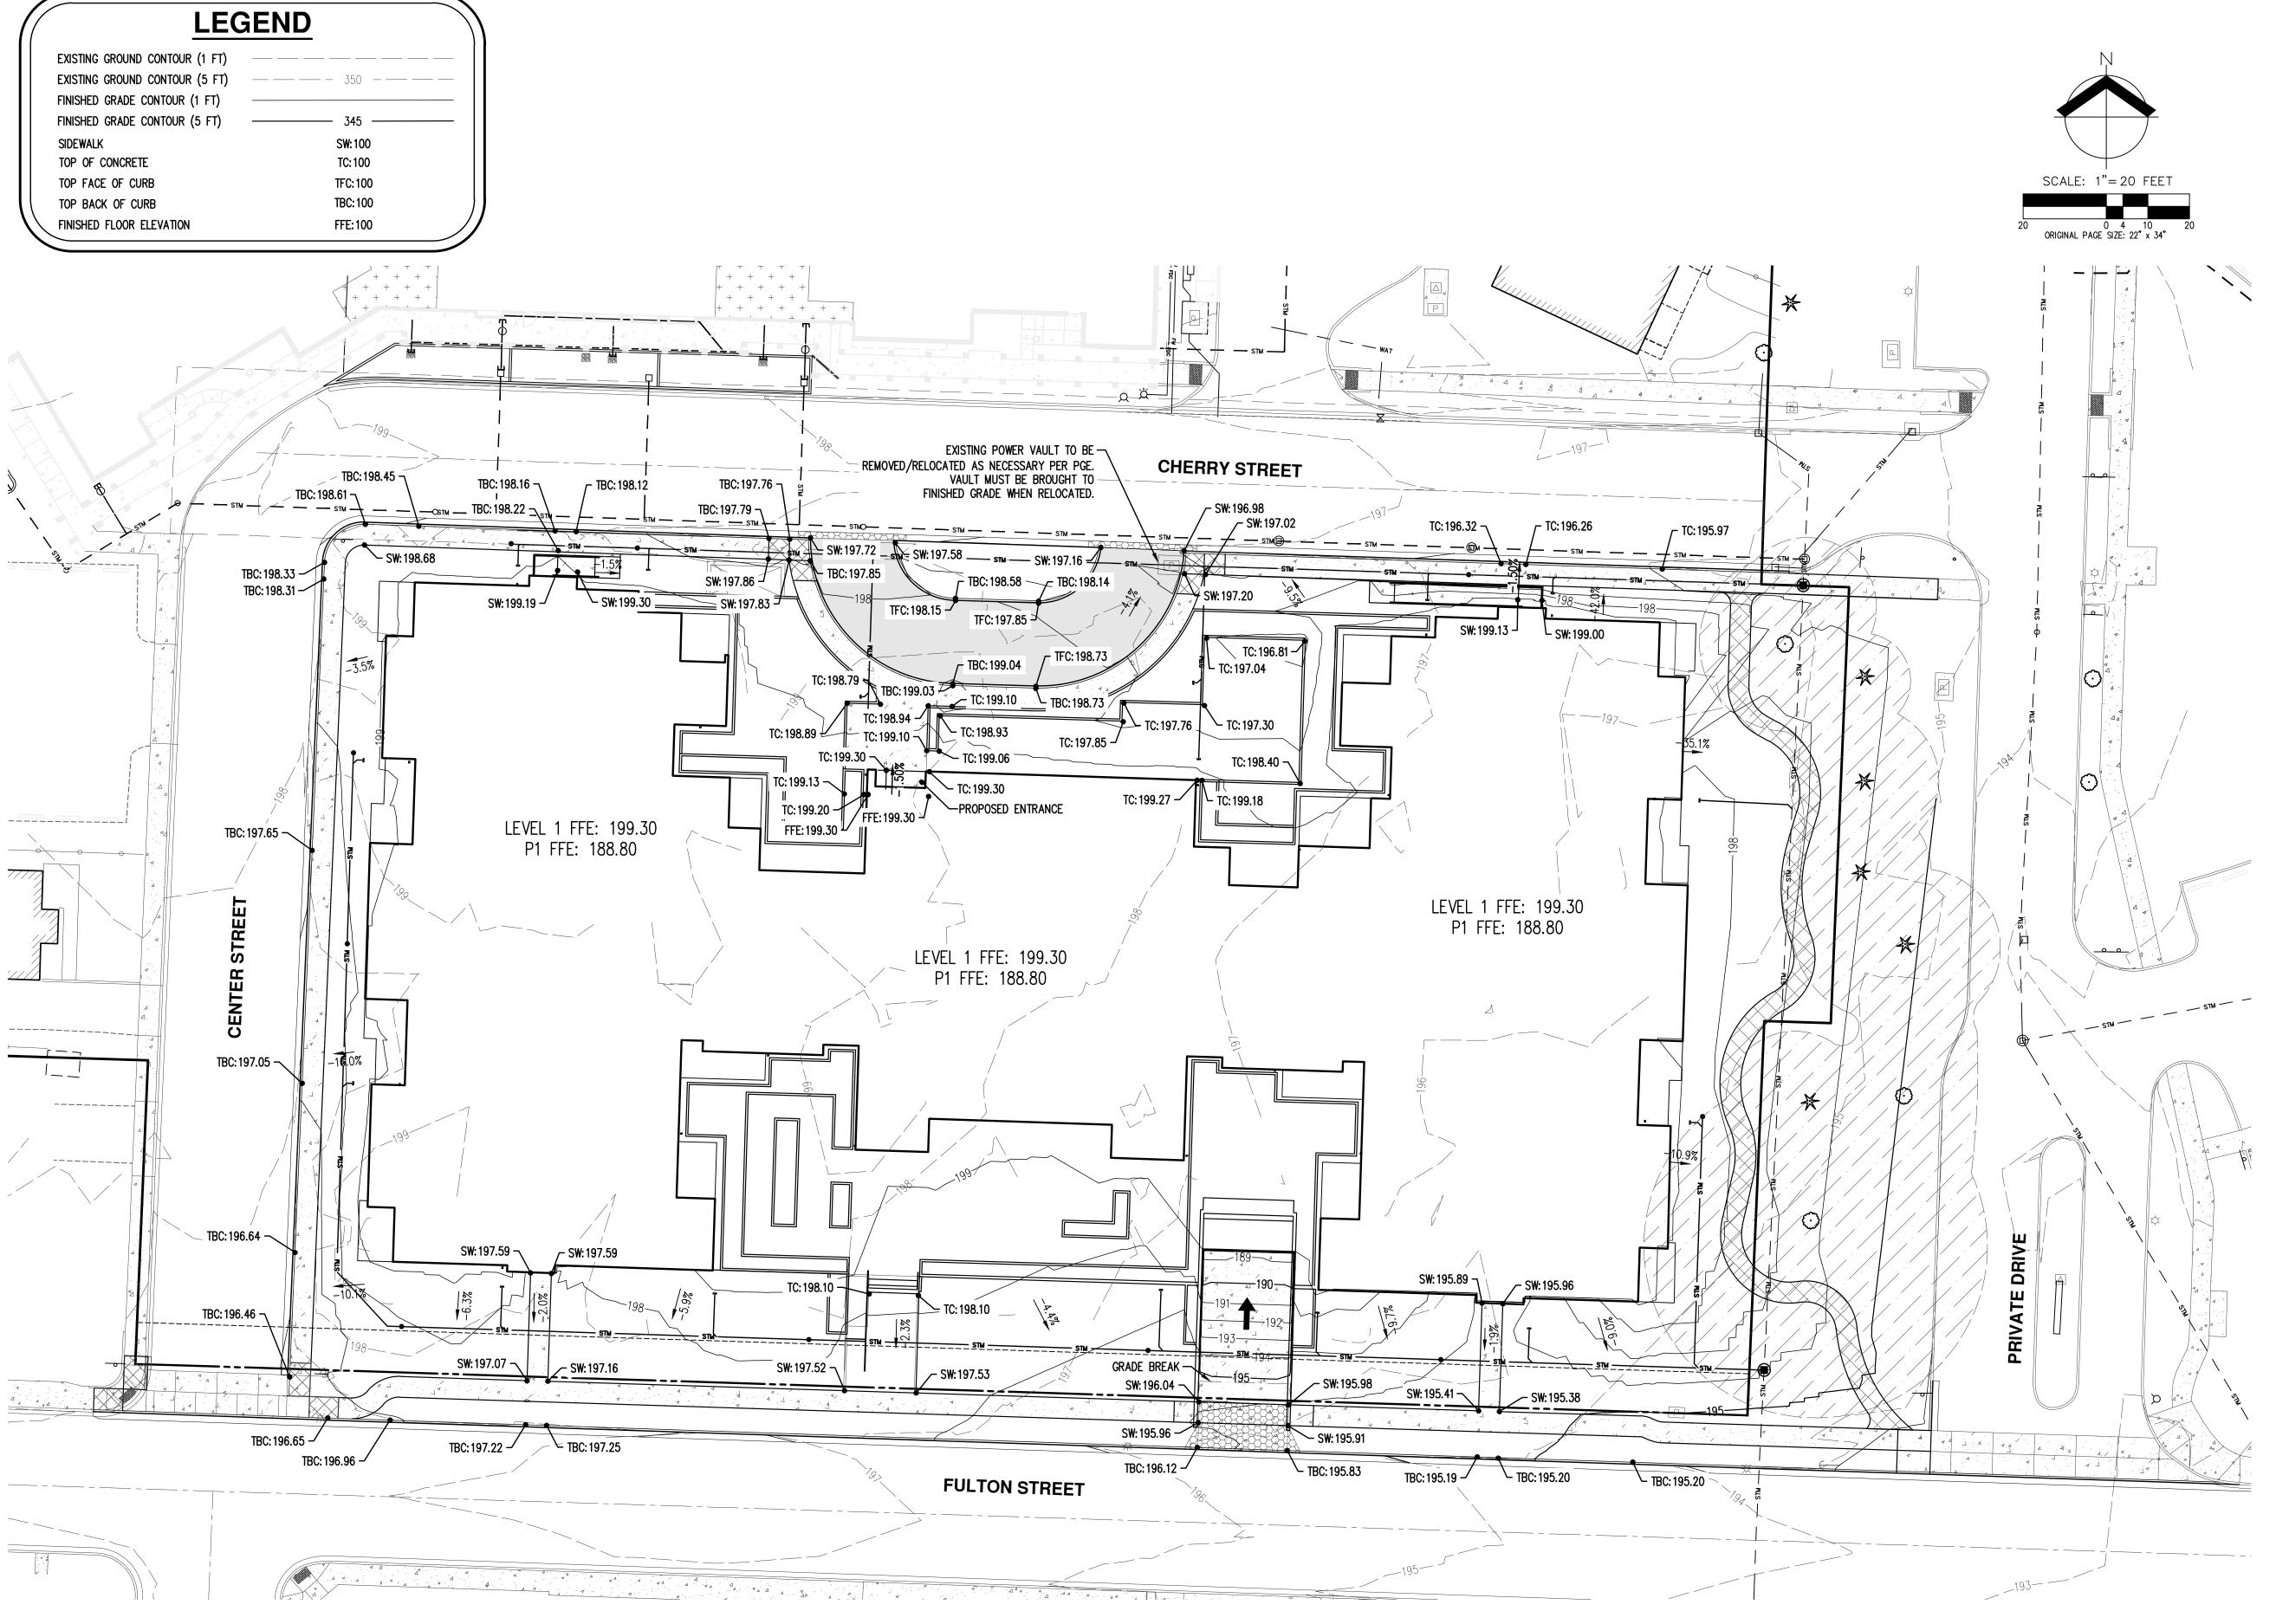


PRELIMINARY
EROSION AND
SEDIMENTATION
CONTROL PLAN

DRAWN BY:


DATE ISSUED:

10/02/20



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SHEET TITLE:


PRELIMINARY

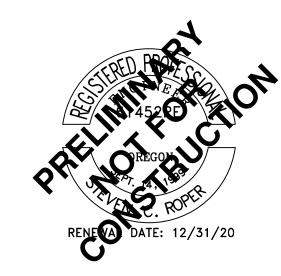GRADING PLAN

DRAWN BY:

DATE ISSUED:

10/02/2020

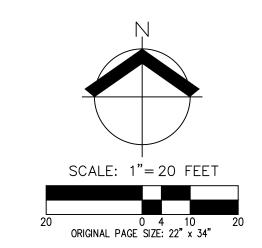



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CONSULTANT:



217304

PROJECT NUMBER:

University Village Phase II 1001 Fulton Street, Newberg OR 97132



SHEET TITLE:

PRELIMINARY


COMPOSITE

UTILITY PLAN

DRAWN BY:

DATE ISSUED:

10/02/2020

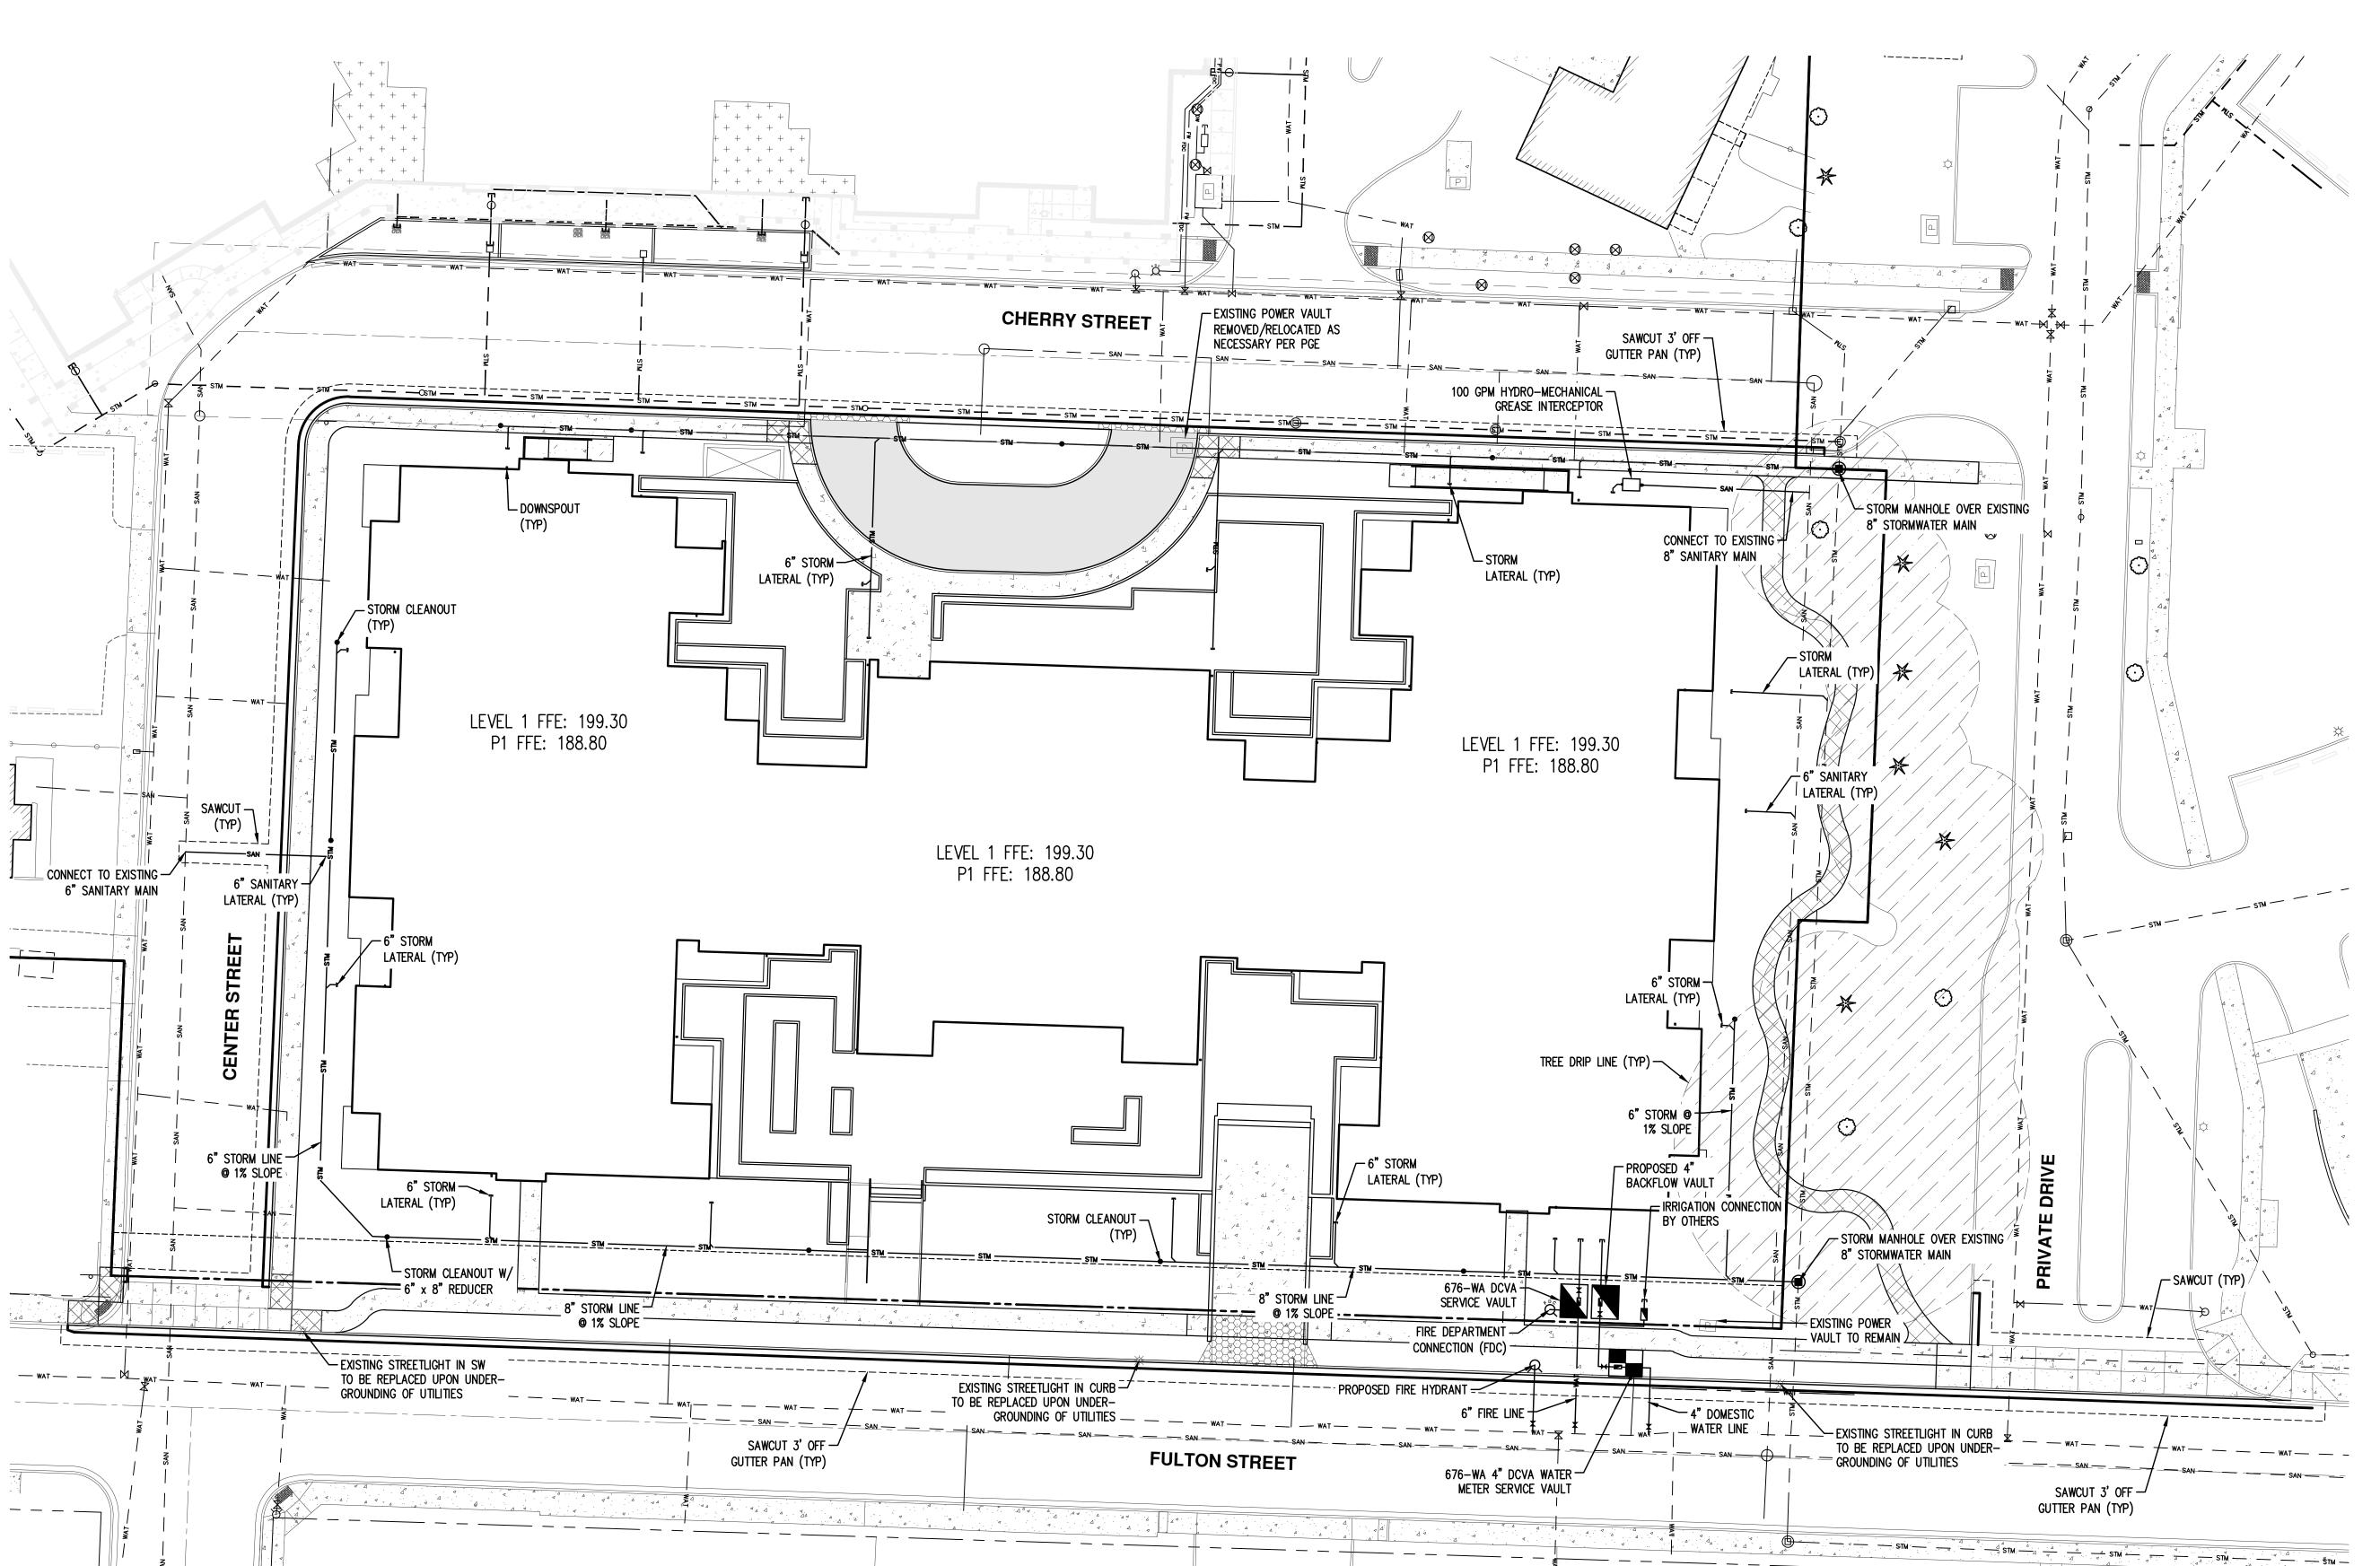



PRELIMINARY NOT FOR CONSTRUCTION

CONSULTANT:

SHAPIRO / DIDWAY

1204 SE Water Ave Portland, Oregon 97214 t. 503.232.0520 www.shapirodidway.com

PROJECT NUMBER: University Village Phase II (Building #1)

1001 Fulton Street, Newberg, OR 97132

Friendsview
RETIREMENT COMMUNITY

SHEET TITLE: EXISTING TREE INVENTORY AND **PROTECTION** PLAN

DRAWN BY:

DATE CREATED:

TREES LEGEND

DECIDUOUS TREE TO REMAIN

EVERGREEN TREE TO REMAIN

INSTALL FENCING PER EXISTING TREE OR TREE PROTECTION PLAN.
WORK WITHIN THE TREE PROTECTION ZONE SHALL BE REVIEWED AND APPROVED BY

THE FOLLOWING IS PROHIBITED WITHIN THE ROOT PROTECTION ZONE OF EACH TREE OR OUTSIDE THE LIMITS OF THE DEVELOPMENT IMPACT AREA: GROUND DISTURBANCE OR CONSTRUCTION ACTIVITY INCLUDING VEHICLE OR EQUIPMENT ACCESS (BUT EXCLUDING ACCESS ON EXISTING STREETS OR DRIVEWAYS), STORAGE OF EQUIPMENT OR MATERIALS INCLUDING SOIL, TEMPORARY OR PERMANENT STOCKPILING, PROPOSED BUILDINGS, IMPERVIOUS SURFACES, UNDERGROUND UTILITIES, EXCAVATION OR FILL, TRENCHING OR

PROTECTIVE FENCE SHALL BE INSTALLED BEFORE ANY GROUND DISTURBING ACTIVITIES

SIGNAGE DESIGNATING THE PROTECTION ZONE AND PENALTIES FOR VIOLATIONS SHALL

TREE PROTECTION ZONE SHALL REMAIN FREE OF ALL CHEMICALLY INJURIOUS MATERIALS

TREE PRESERVATION LEGEND EXISTING TREES TO BE PROTECTED/REMOVED

Maple (Acer sp.)

Douglas Fir (Pseudotsuga menziesii) Pine (Pinus sp.)

Pine (Pinus sp.)

Giant Sequoia (Sequoiadendron giganteum)

California Black Oak (Quercus kelloggii)

Pine (Pinus sp.)

California Black Oak (Quercus kelloggii)

BE SECURED IN A PROMINENT LOCATION ON EACH PROTECTION FENCE.

INCLUDING CLEARING AND GRADING, OR CONSTRUCTION STARTS; AND SHALL REMAIN IN

EXCAVATION WITHIN THE TREE PROTECTION ZONE SHALL BE PERFORMED WITH HANDHELD TOOLS OR AIR SPADE. EXCAVATE THE MINIMUM AMOUNT NECESSARY TO

TREE ROOTZONE

ACCOMPLISH PURPOSE FOR EXCAVATION.

OTHER WORK ACTIVITIES.

AND LIQUIDS.

DECIDUOUS

EV/CONIFER

EV/CONIFER

EV/CONIFER

EV/CONIFER


DECIDUOUS

EV/CONIFER

DECIDUOUS

PLACE UNTIL FINAL INSPECTION.

1/16" = 1'-0"

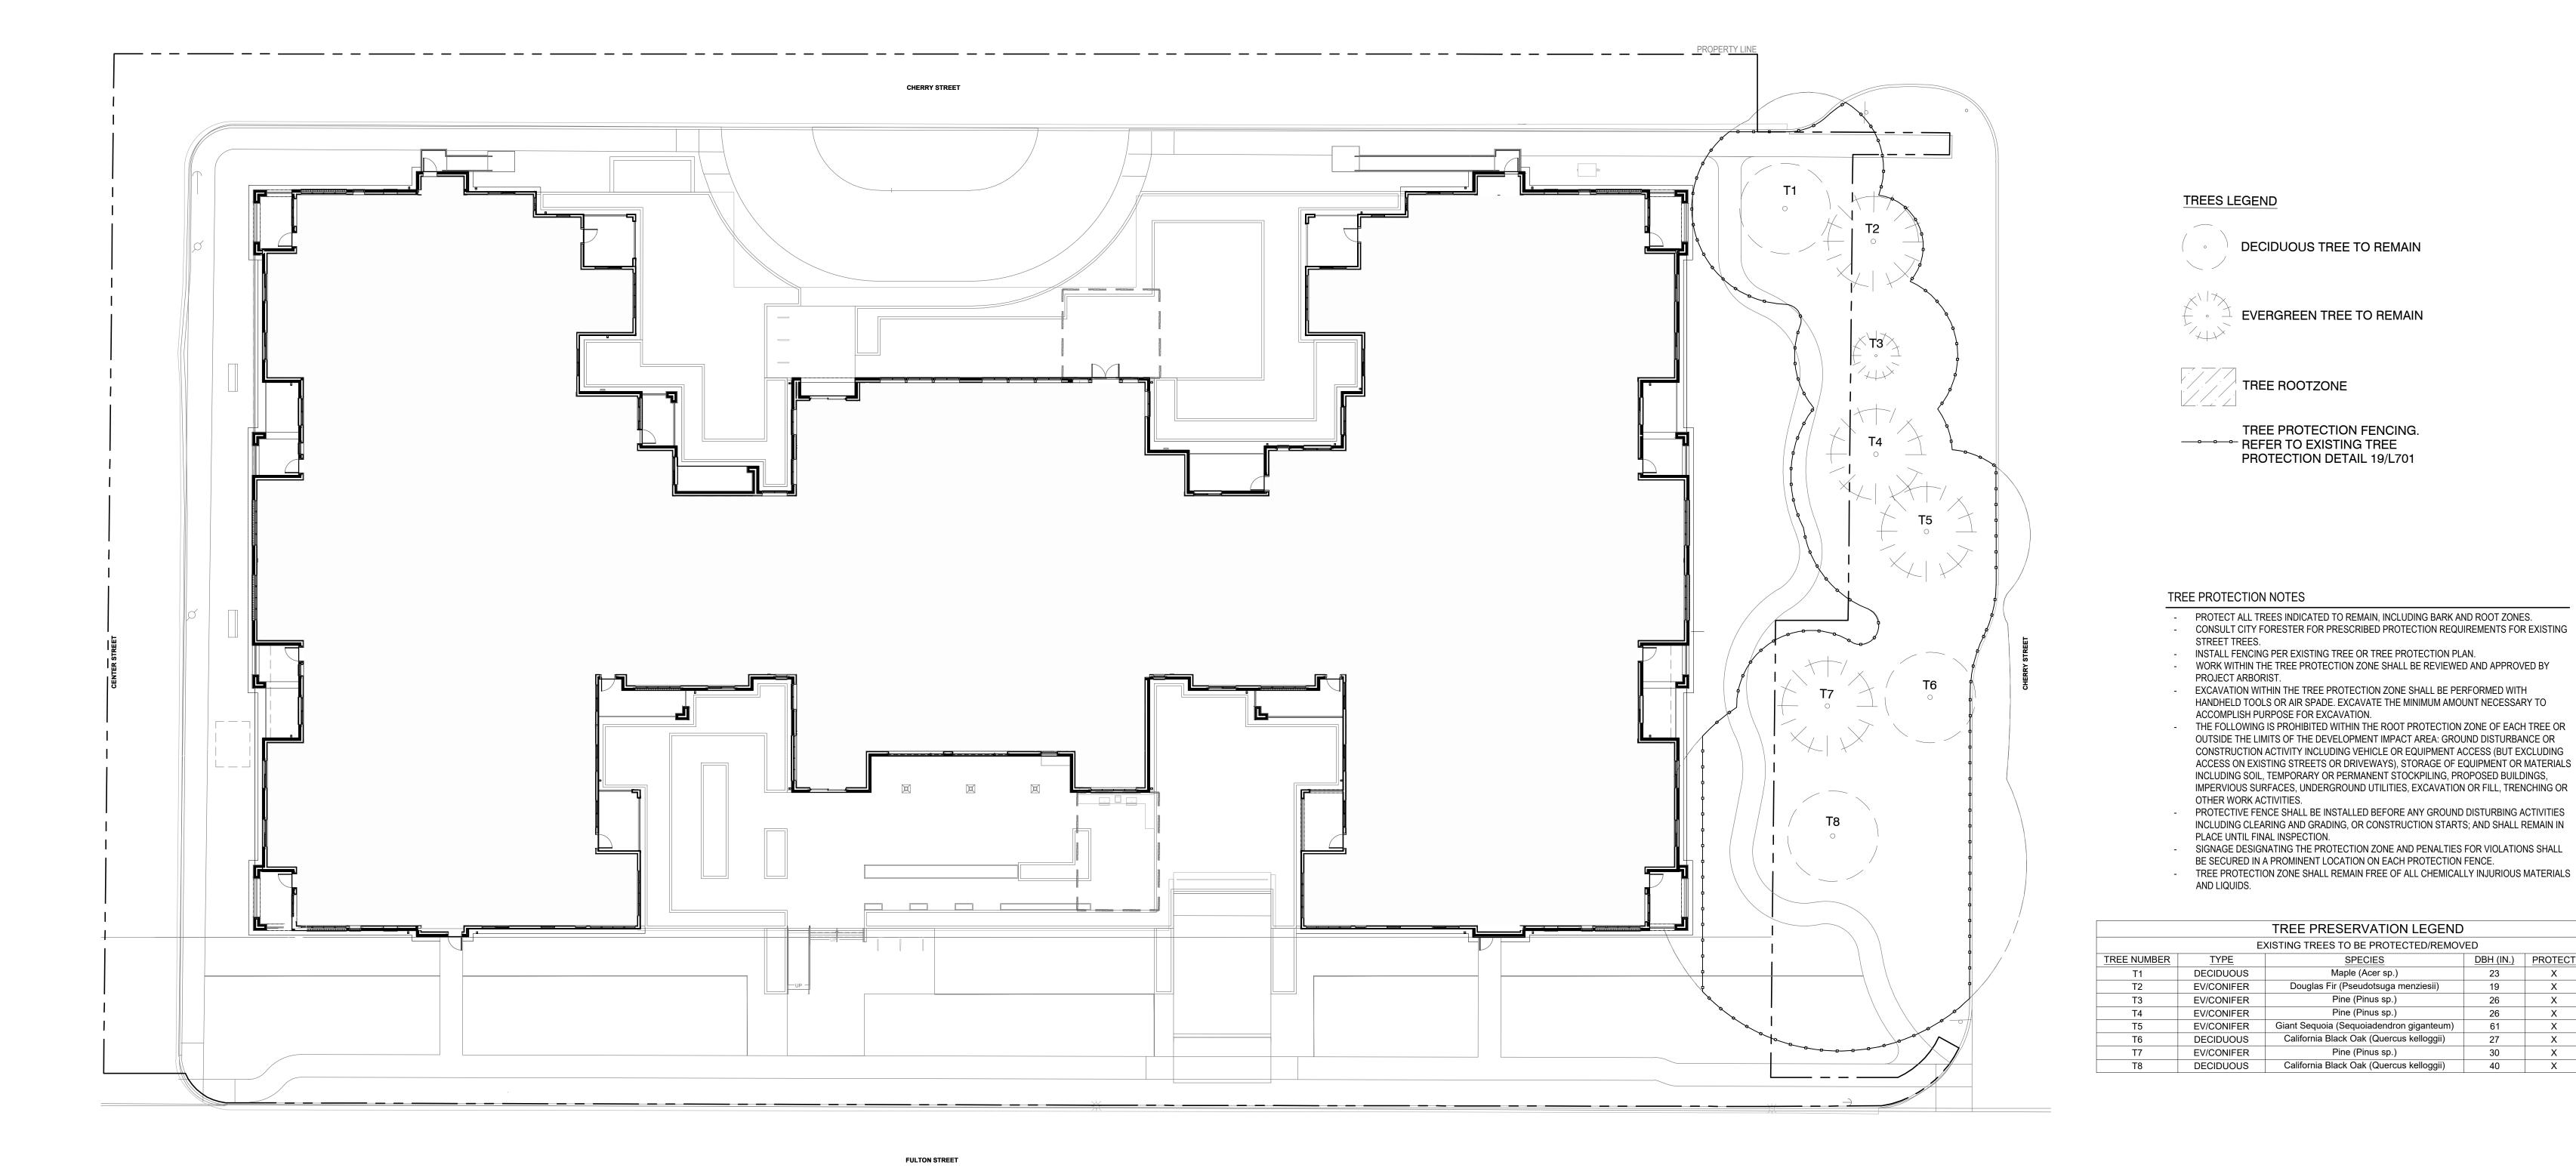

EXISTING TREE INVENTORY AND PROTECTION PLAN

TRUE NORTH



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PROJECT NUMBER: *University Village Phase II (Building #1)*

1001 Fulton Street, Newberg, OR 97132


Friendsview
RETIREMENT COMMUNITY

SHEET TITLE: *LANDSCAPE* SITE MATERIALS

PLAN

TRUE NORTH

DRAWN BY: DATE CREATED:

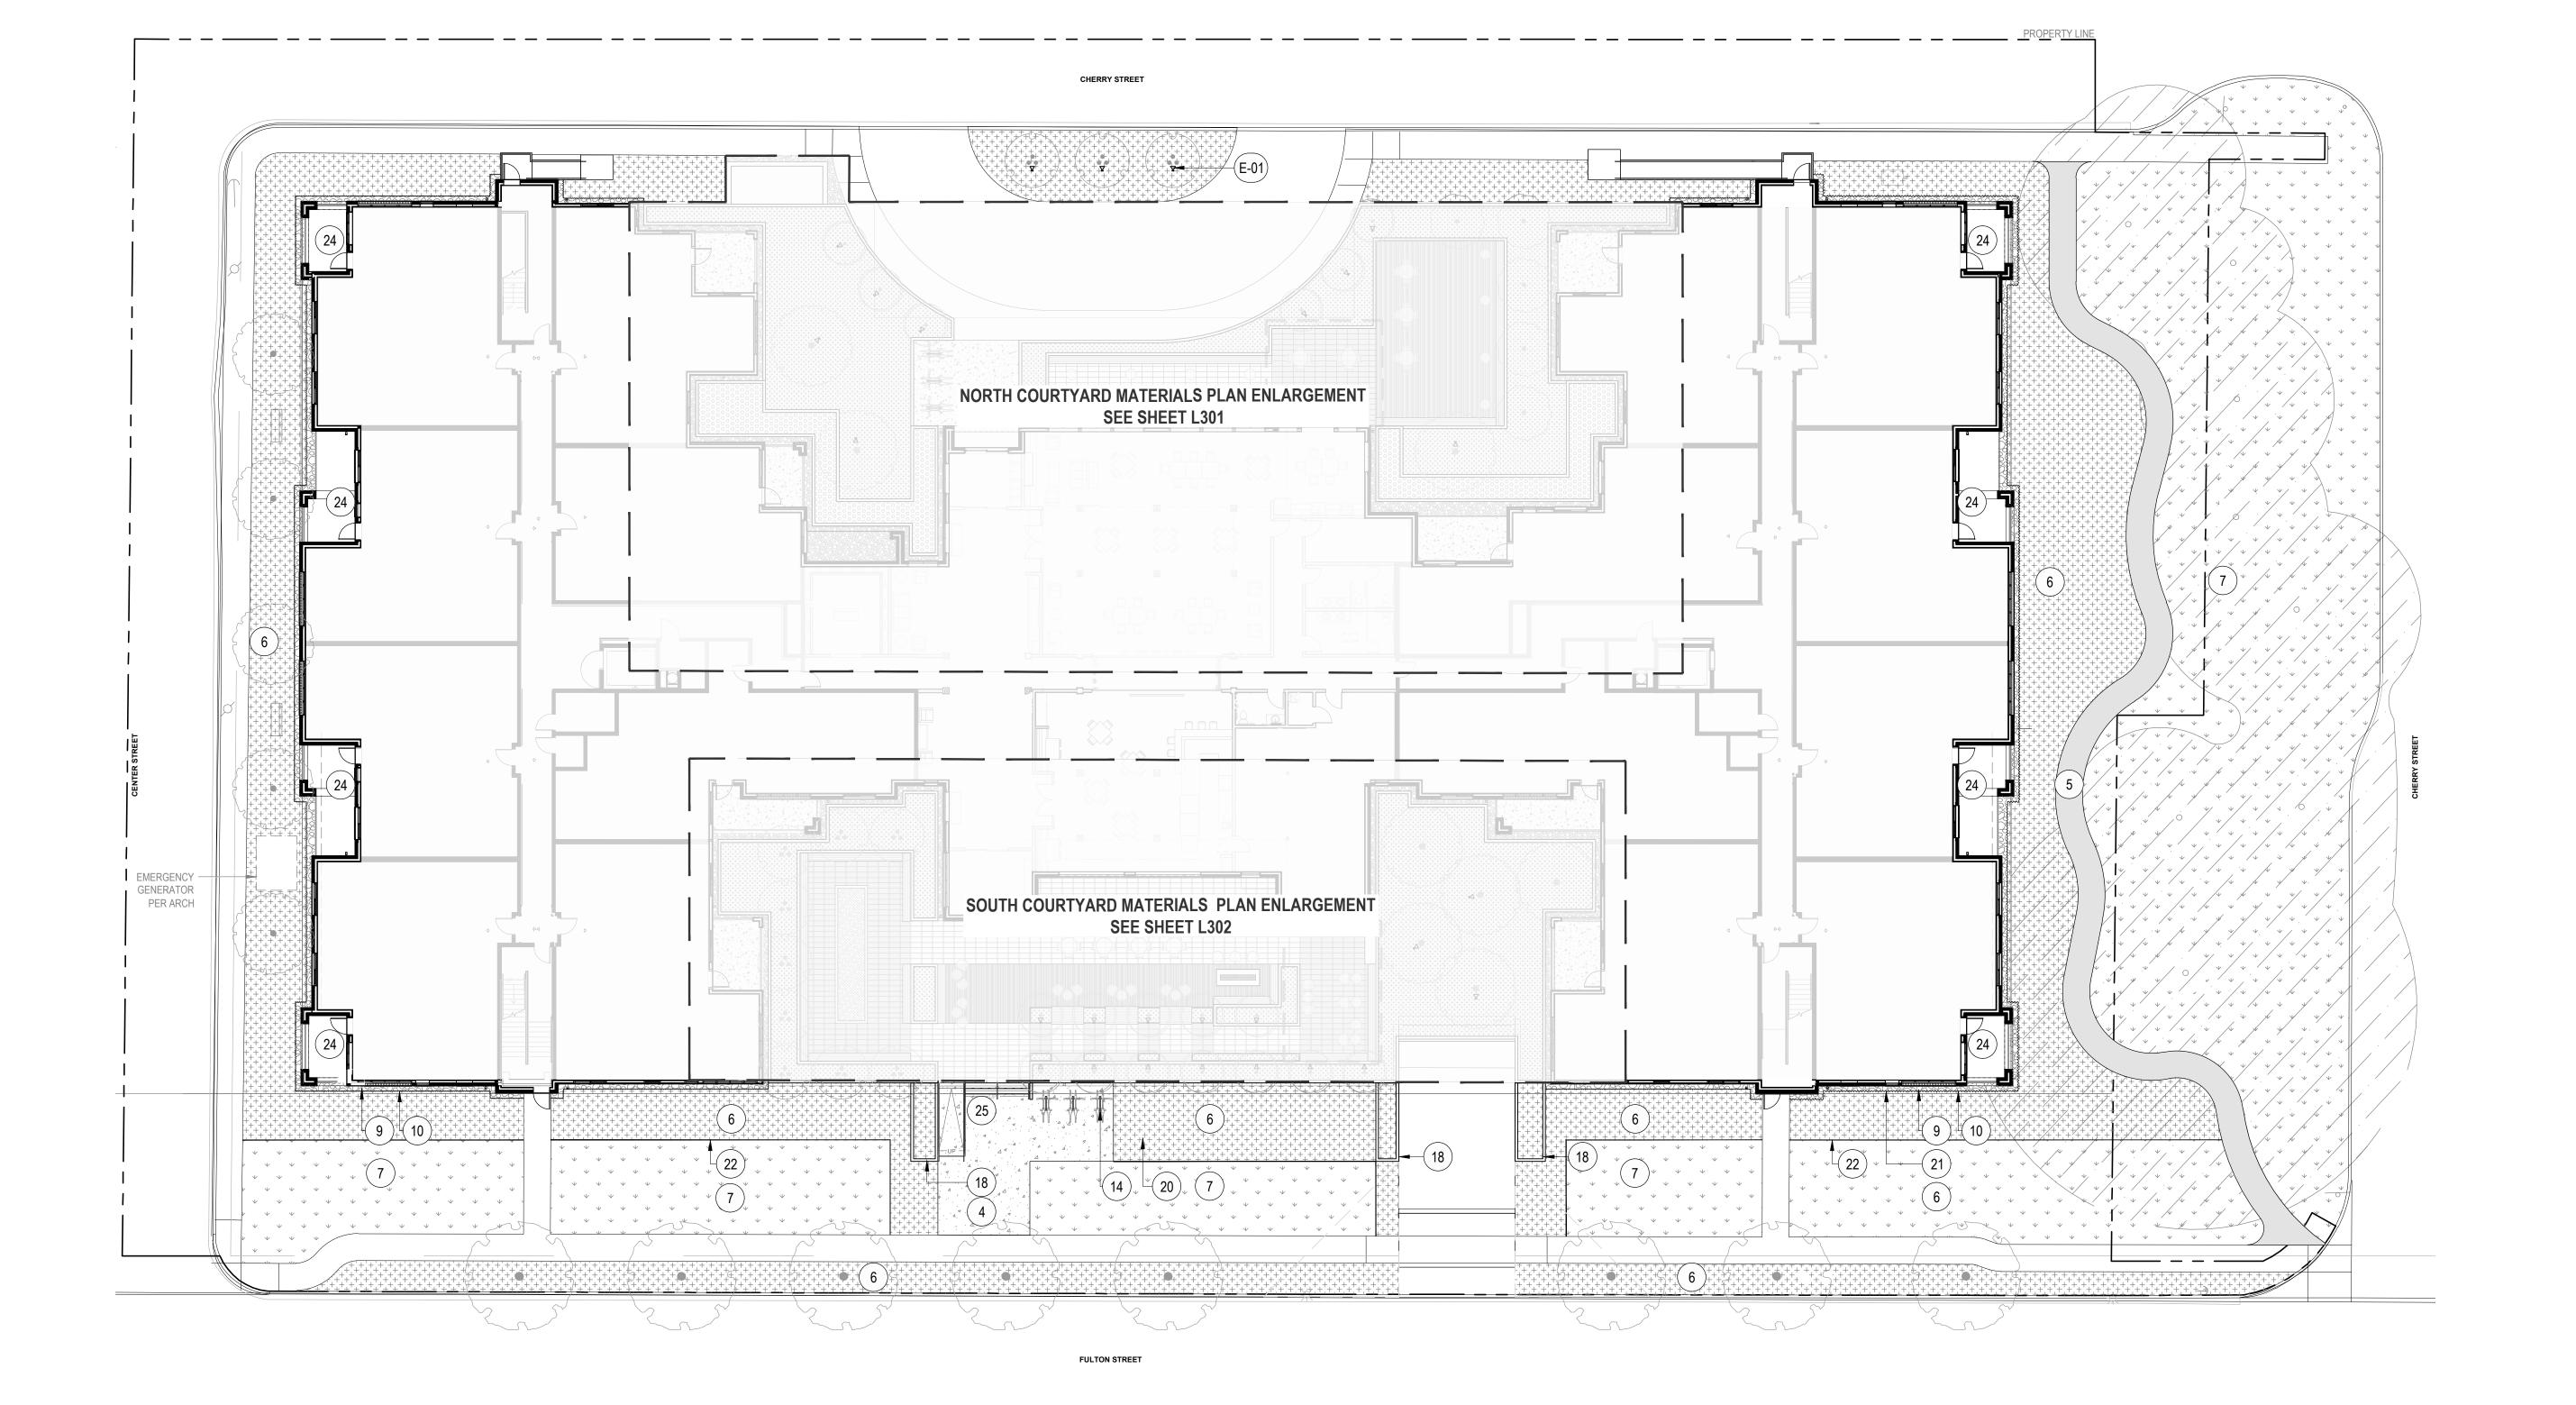

1) LANDSCAPE SITE MATERIALS PLAN

1/16" = 1'-0" NORTH

REFERENCE NOTES SCHEDULE - ON SITE

CONCRETE SURFACING, TYP.

DECORATIVE STONE MAINTENANCE EDGE

ENTRY STAIRCASE AND RAMP W/ HANDRAILS

METAL EDGE RESTRAINT, TYP.

RAISED CONCRETE PLANTER

METAL EDGE RESTRAINT, TYP.

LOW VOLTAGE UPLIGHT, TYP.

REFERENCE NOTES SCHEDULE - RIGHT OF WAY

PLANTING AREA, TYP.

DESCRIPTION

CONCRETE EDGE BAND

SHOVEL CUT EDGE, TYP.


UNIT PATIO

ELECTRICAL DESCRIPTION


ASPHALT SURFACING

PLANTING AREA, TYP.

TURF AREA, TYP.

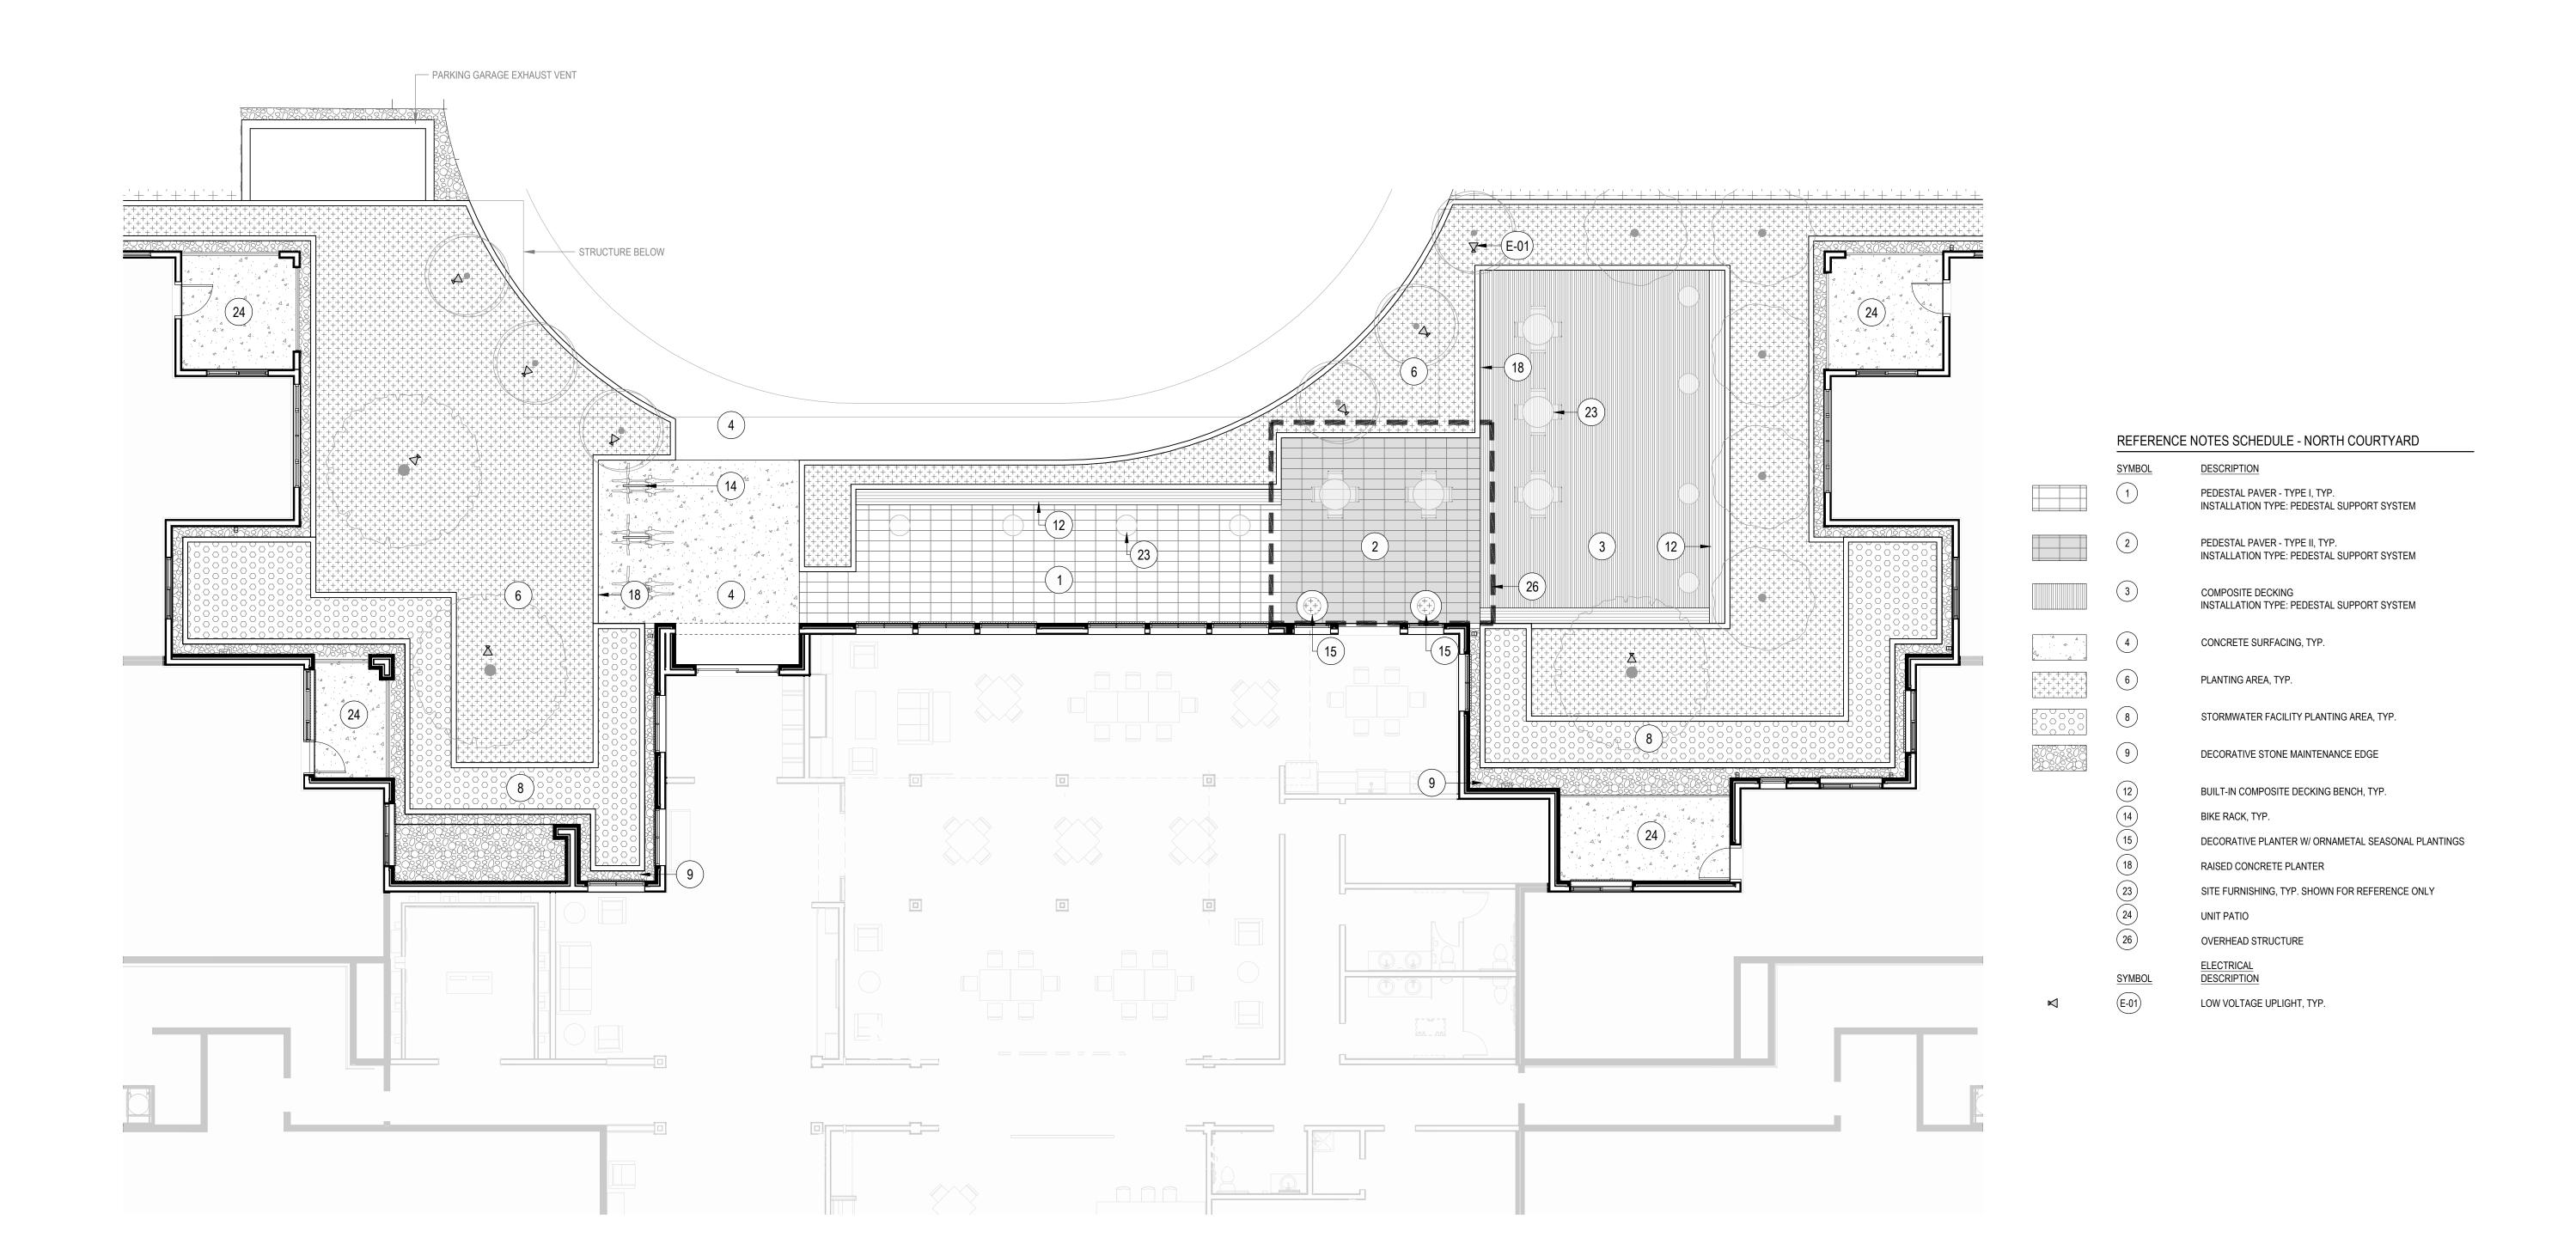

NORTH COURTYARD MATERIALS PLAN ENLARGEMENT

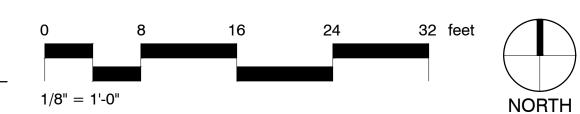



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SHAPIRO / DIDWA


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University
Village Phase II
(Building #1)

1001 Fulton Street, Newberg, OR 97132




NORTH
COURTYARD
MATERIALS
PLAN
ENLARGEMENT

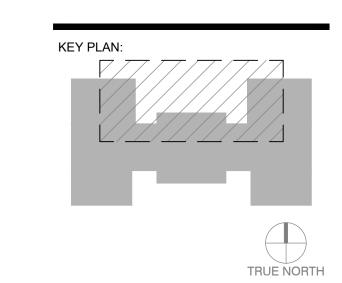

DRAWN BY: DATE CREATED:



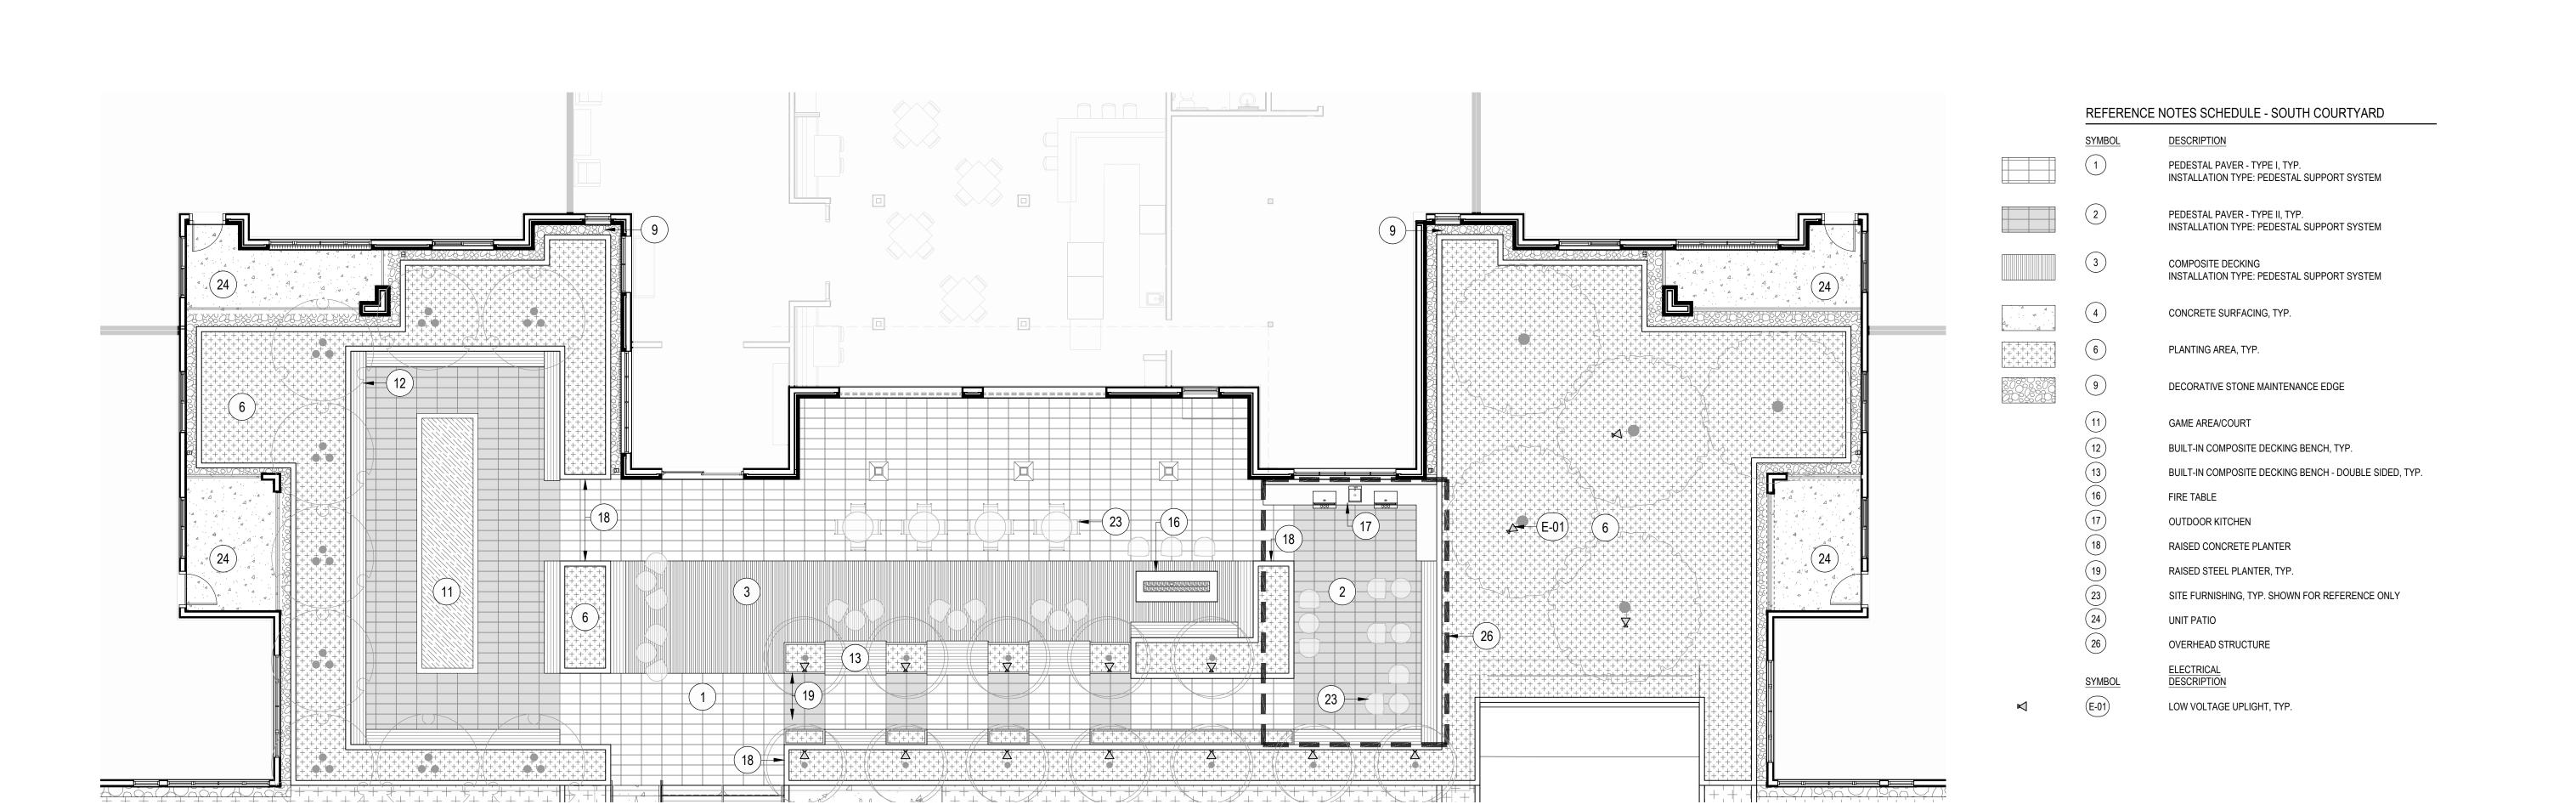

SOUTH COURTYARD MATERIALS PLAN ENLARGEMENT

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CONSULTANT:

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University
Village Phase II
(Building #1)

1001 Fulton Street, Newberg, OR 97132




SHEET TITLE:
SOUTH
COURTYARD
MATERIALS
PLAN
ENLARGEMENT

KEY PL

NORTH

1/8" = 1'-0"

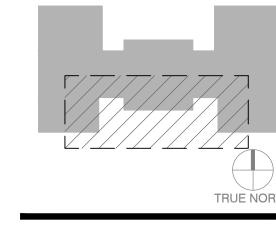

DRAWN BY: DATE CREATED:



ANDSCAPE AREA:	
OT AREA OF DISTURBANCE:	77,557 SI
ANDSCAPE AREA:	30,814 SI
OT LANDSCAPE PERCENTAGE:	39.7%

PROPERTY LINE

CHERRY STREET

NORTH COURTYARD PLANTING PLAN ENLARGEMENT

SEE SHEET L501

SOUTH COURTYARD PLANTING PLAN ENLARGEMENT

SEE SHEET L502

PLANTING NOTES:

- A. DO NOT WILLFULLY PROCEED WITH PLANTING OPERATIONS WHEN IT IS OBVIOUS THAT UNKNOWN OBSTRUCTIONS AND GRADE DIFFERENCES EXIST THAT MAY NOT HAVE BEEN KNOWN THE DURING DESIGN PROCESS. BRING SUCH CONDITIONS IMMEDIATELY TO ATTENTION OF OWNER'S AUTHORIZED REPRESENTATIVE FOR RESOLUTION. ASSUME FULL RESPONSIBILITY FOR COSTS INCURRED AND REQUIRED MODIFICATIONS DUE TO LACK OF PROVIDING SUCH NOTIFICATION.
- B. ENSURE THAT FINISH GRADE ELEVATIONS OF PLANTING AREAS ARE SET AT THE PROPER ELEVATIONS RELATIVE TO PAVING FINISH SURFACE ELEVATIONS, UTILITY COVERS AND CURBS. SHRUBS PLANTING AREAS AT 2" BELOW AND LAWN 1" BELOW ADJACENT GRADE. NOTIFY OWNER OF ANY DISCREPANCIES.
- C. ASSURE POSITIVE DRAINAGE IN ALL PLANTING AREAS TO DRAIN AWAY FROM BUILDING, 2% MINIMUM.
- B. QUANTITIES GIVEN FOR PLAN MATERIALS SPECIFIED FOR "ON CENTER" SPACING ARE SHOWN FOR CONVENIENCE ONLY AND ARE SUBORDINATE TO THE SPACING GIVEN. VERIFY AND
- SUPPLY SUFFICIENT NUMBER OF PLANTS TO FULFILL SPACING REQUIREMENTS. C. EXACT LOCATIONS OF PLANT MATERIALS TO BE APPROVED BY THE LANDSCAPE ARCHITECT IN THE FIELD. STAGE ALL PLANT MATERIAL ONSITE PER PLAN, IN THE PLANT CONTAINERS. LARGER TREES MAY BE CENTER MARKED BY PAINTING OR STAKES. NOTIFY LANDSCAPE ARCHITECT OF PLACEMENT 48 HOURS PRIOR TO REQUIRED INSPECTION BY LANDSCAPE ARCHITECT. LANDSCAPE ARCHITECT RESERVES THE RIGHT TO ADJUST PLANT PLACEMENT WHILE STILL IN THE CONTAINERS, AT NO ADDITIONAL COST TO THE OWNER, BEFORE GIVING APPROVAL TO THE FINAL LOCATION FOR PLANTING.
- F. PLANTING SHALL NOT BE PERFORMED PRIOR TO THE FOLLOWING APPROVAL BY THE OWNERS AUTHORIZED REQPRESENTATIVE:
- OPERATIONAL IRRIGATION SYSTEM PROVIDING HEAD TO HEAD COVERAGE. DECOMPACTION AND PRE-PLANTING SOIL AMENDMENTS ARE COMPLETE.
- G. IF CONFLICTS ARISE BETWEEN ACTUAL SIZE OF PLANTING AREAS ON-SITE AND THOSE AREAS INDICATED ON DRAWINGS, NOTIFY THE OWNER'S AUTHORIZED REPRESENTATIVE PRIOR TO • ALL EXPOSED SOIL PLANTING AREAS TO RECEIVE A 3-INCH DEEP LAYER OF LANDSCAPE
- ARCHITECT APPROVED MULCH. PROVIDE ROOT CONTROL BARRIERS FOR ALL TREES PLANTED WITHIN 5' OF A HARDSCAPE EDGE OF PAVING. REFER TO PLANTING DETAILS FOR ADDITIONAL INFORMATION.
- INSTALL PLANT MATERIAL WITH ITS BEST SIDE FACING PREDOMINATE VIEW OF PUBLIC. PROVIDE THE PROPER SETBACK BETWEEN UTILITIES AND TREES - CONTACT CITY INSPECTOR FOR REQUIRED SETBACKS IN THE CASE THAT THE DRAWINGS ARE NOT CLEAR. PROVIDE A 4 FT. DIAMETER MULCH CIRCLE AROUND ALL TREES PLANTED IN LAWN AREAS
- UNLESS NOTED OTHERWISE. PLANT SUBSTITUTIONS DUE TO AVAILABILITY, SHALL BE SUBMITTED IN WRITING TO LANDSCAPE ARCHITECT FOR APPROVAL.
- H. ALL PLANTING WITHIN THE RIGHT OF WAY SHALL MEET THE LOCAL JURISDICTION REQUIREMENTS, PLANTING STANDARDS, AND SITE VISION TRIANGLE CLEARANCE STANDARDS. I. CLEAR AND GRUB ALL INVASIVE VEGETATION. VERIFY ACTION FOR ALL NON-INVASIVE

VEGETATION WITH LANDSCAPE ARCHITECT UNLESS OTHERWISE NOTED IN PLANS.

(cs)	CS	CAMELLIA SASANQUA `GREEN 02-004` TM OCTOBER MAGIC WHITE SHI-SHI CAMELLIA	5 GAL	
СТ	СТ	CHOISYA TERNATA `AZTEC PEARL` MEXICAN ORANGE	5 GAL	
CI	CI	CISTUS X AGUILARII 'MACULATUS' ROCKROSE	5 GAL	
(IL)	IL	ILEX X MESERVEAE 'CASTLE WALL' CASTLE WALL HOLLY	5 GAL	
RL	RL	RHODODENDRON DORA AMATEIS LOW WHITE RHODODENDRON	5 GAL	
TB	ТВ	ROSMARINUS OFFICINALIS 'TUSCAN BLUE' TUSCAN BLUE ROSEMARY	5 GAL	
SR	SR	SARCOCOCCA RUSCIFOLIA FRAGRANT SARCOCOCCA	5 GAL	
GRASSES	CODE	BOTANICAL / COMMON NAME	SIZE	<u>HT.</u>
CA	CA	CALAMAGROSTIS X ACUTIFLORA 'KARL FOERSTER' FEATHER REED GRASS	3 GAL	
SHRUB AREAS	CODE	BOTANICAL / COMMON NAME	CONT	
	AU	ARCTOSTAPHYLOS UVA-URSI KINNIKINNICK	1 GAL	
	LO	LONICERA PILEATA PRIVET HONEYSUCKLE	5 GAL	
	RO	ROSA X 'NOASCHNEE' WHITE GROUNDCOVER ROSE	3 GAL	
ORNAMENTAL GRASS AREAS	CODE	BOTANICAL / COMMON NAME	CONT	
	PEAL	PENNISETUM ALOPECUROIDES `HAMELN` HAMELN DWARF FOUNTAIN GRASS	2 GAL	
GROUND COVERS	CODE	BOTANICAL / COMMON NAME	CONT	
	ARUV	ARCTOSTAPHYLOS UVA-URSI `MASSACHUSETTS` MASSACHUSETTS MANZANITA	1 GAL	
	LIMU	LIRIOPE MUSCARI `BIG BLUE` BIG BLUE LILYTURF	1 GAL	
SEEDED LAWN	CODE	BOTANICAL / COMMON NAME	CONT	
	LAWN	LAWN	HYDROSEED	
V / / / /		SUNMARK SEED NORTHWEST PREMIUM BLEND		
		10# PER 1,000 SF		

PLANT SCHEDULE - ON SITE

CODE BOTANICAL / COMMON NAME

LA LAGERSTROEMIA X 'NATCHEZ'

MULTI-STEM

VM ACER CIRCINATUM

VINE MAPLE

LIMBED-UP 7 FT

CODE BOTANICAL / COMMON NAME

U+25AA MULTI-STEM

U+25AA LIMBED-UP 5 FT

CK CORNUS KOUSA X NUTTALLII 'KN4-43'

STARLIGHT KOUSA DOGWOOD

WHITE CRAPE MYRTLE MULTI-TRUNK

<u>CONT</u> <u>CAL</u>

25 GAL 8-10 FT.

2" CAL

B & B

B & B

SIZE

SIZE

12-15` H

MULTI-TRUNK 12-14` H

ARCHITECTS

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PRELIMINARY

NOT FOR

CONSTRUCTION

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CONSULTANT:

PROJECT NUMBER:

University Village Phase II (Building #1)

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Newberg, OR 97132


Suite 300 503.221.2077

TREES

SHRUB AREAS			
	CODE	BOTANICAL / COMMON NAME	CONT
	AU	ARCTOSTAPHYLOS UVA-URSI KINNIKINNICK	1 GAL
	LO	LONICERA PILEATA PRIVET HONEYSUCKLE	5 GAL
	RO	ROSA X 'NOASCHNEE' WHITE GROUNDCOVER ROSE	3 GAL
ORNAMENTAL GRASS AREAS	CODE	BOTANICAL / COMMON NAME	CONT
	PEAL	PENNISETUM ALOPECUROIDES `HAMELN` HAMELN DWARF FOUNTAIN GRASS	2 GAL
GROUND COVERS	CODE	BOTANICAL / COMMON NAME	CONT
	ARUV	ARCTOSTAPHYLOS UVA-URSI `MASSACHUSETTS` MASSACHUSETTS MANZANITA	1 GAL
	LIMU	LIRIOPE MUSCARI 'BIG BLUE' BIG BLUE LILYTURF	1 GAL
SEEDED LAWN	CODE	BOTANICAL / COMMON NAME	CONT
/	LAWN	LAWN	HYDROSEED
<u>////</u>		SUNMARK SEED NORTHWEST PREMIUM BLEND	
		10# PER 1,000 SF	

Friendsview RETIREMENT COMMUNITY

SHEET TITLE:	
SITE PLANTING	
PLAN	

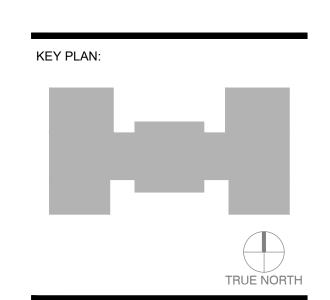

DRAWN BY: DATE CREATED:

PLANT GROUP B CISTUS X AGUILARII 'MACULATUS' / ROCKROSE IRIS TENAX / OREGON IRIS PENNISETUM ALOPECUROIDES 'HAMELN' / HAMELN DWARF FOUNTAIN GRASS	5 GAL 1 GAL 2 GAL	40% @ 36" oc 10% @ 12" oc 50% @ 18" oc
PLANT GROUP C ARCTOSTAPHYLOS UVA-URSI 'MASSACHUSETTS' / MASSACHUSETTS MANZANITA DESCHAMPSIA CESPITOSA / TUFTED HAIR GRASS GAULTHERIA SHALLON / SALAL POLYSTICHUM MUNITUM / WESTERN SWORD FERN RIBES SANGUINEUM / RED FLOWERING CURRANT VACCINIUM OVATUM / EVERGREEN HUCKLEBERRY	1 GAL 1 GAL 1 GAL 2 GAL 5 GAL 5 GAL	15% @ 15" oc 10% @ 18" oc 35% @ 18" oc 20% @ 24" oc 10% @ 36" oc 10% @ 36" oc

PENNISETUM ALOPECUROIDES 'HAMELN' / HAMELN DWARF FOUNTAIN GRASS

PLANT SCHEDULE - RIGHT OF WAY						
TREES	CODE	BOTANICAL / COMMON NAME	<u>C</u>			
5000	79	ZELKOVA SERRATA 'GREEN VASE' / GREEN VASE SAWLEAE ZELKOVA	P			

	ZS	ZELKOVA SERRATA `GREEN VASE` / GREEN VASE SAWLEAF ZELKOVA	B & B
IRUB AREAS	CODE	BOTANICAL / COMMON NAME	CONT
	LO	LONICERA PILEATA / PRIVET HONEYSUCKLE	5 GAL

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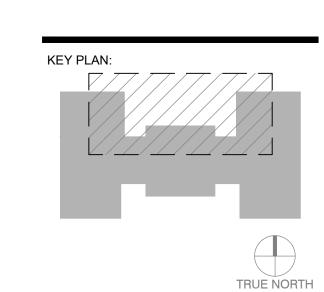
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University
Village Phase II
(Building #1)

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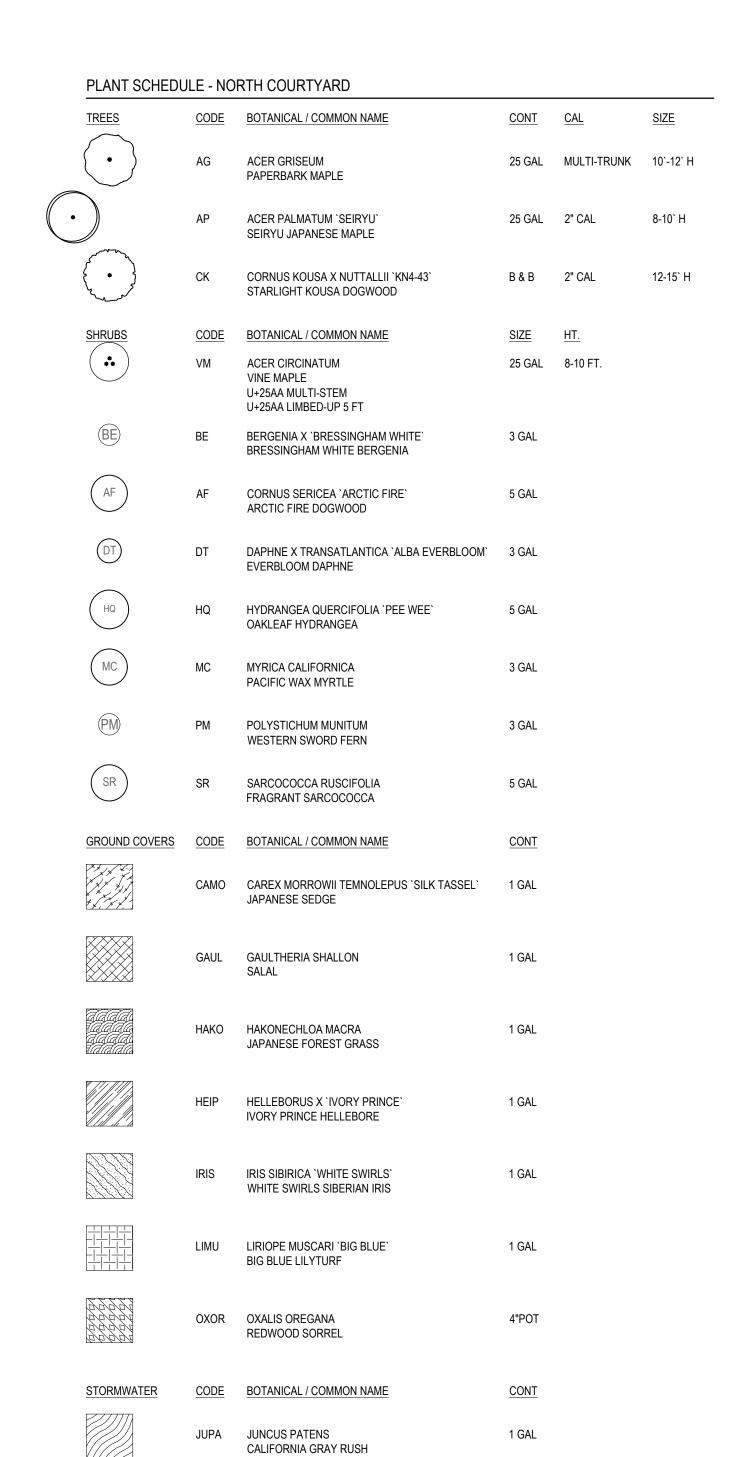


SHEET TITLE:
NORTH
COURTYARD
PLANTING
PLAN
ENLARGEMENT




DRAWN BY: DATE CREATED:





1/8" = 1'-0"

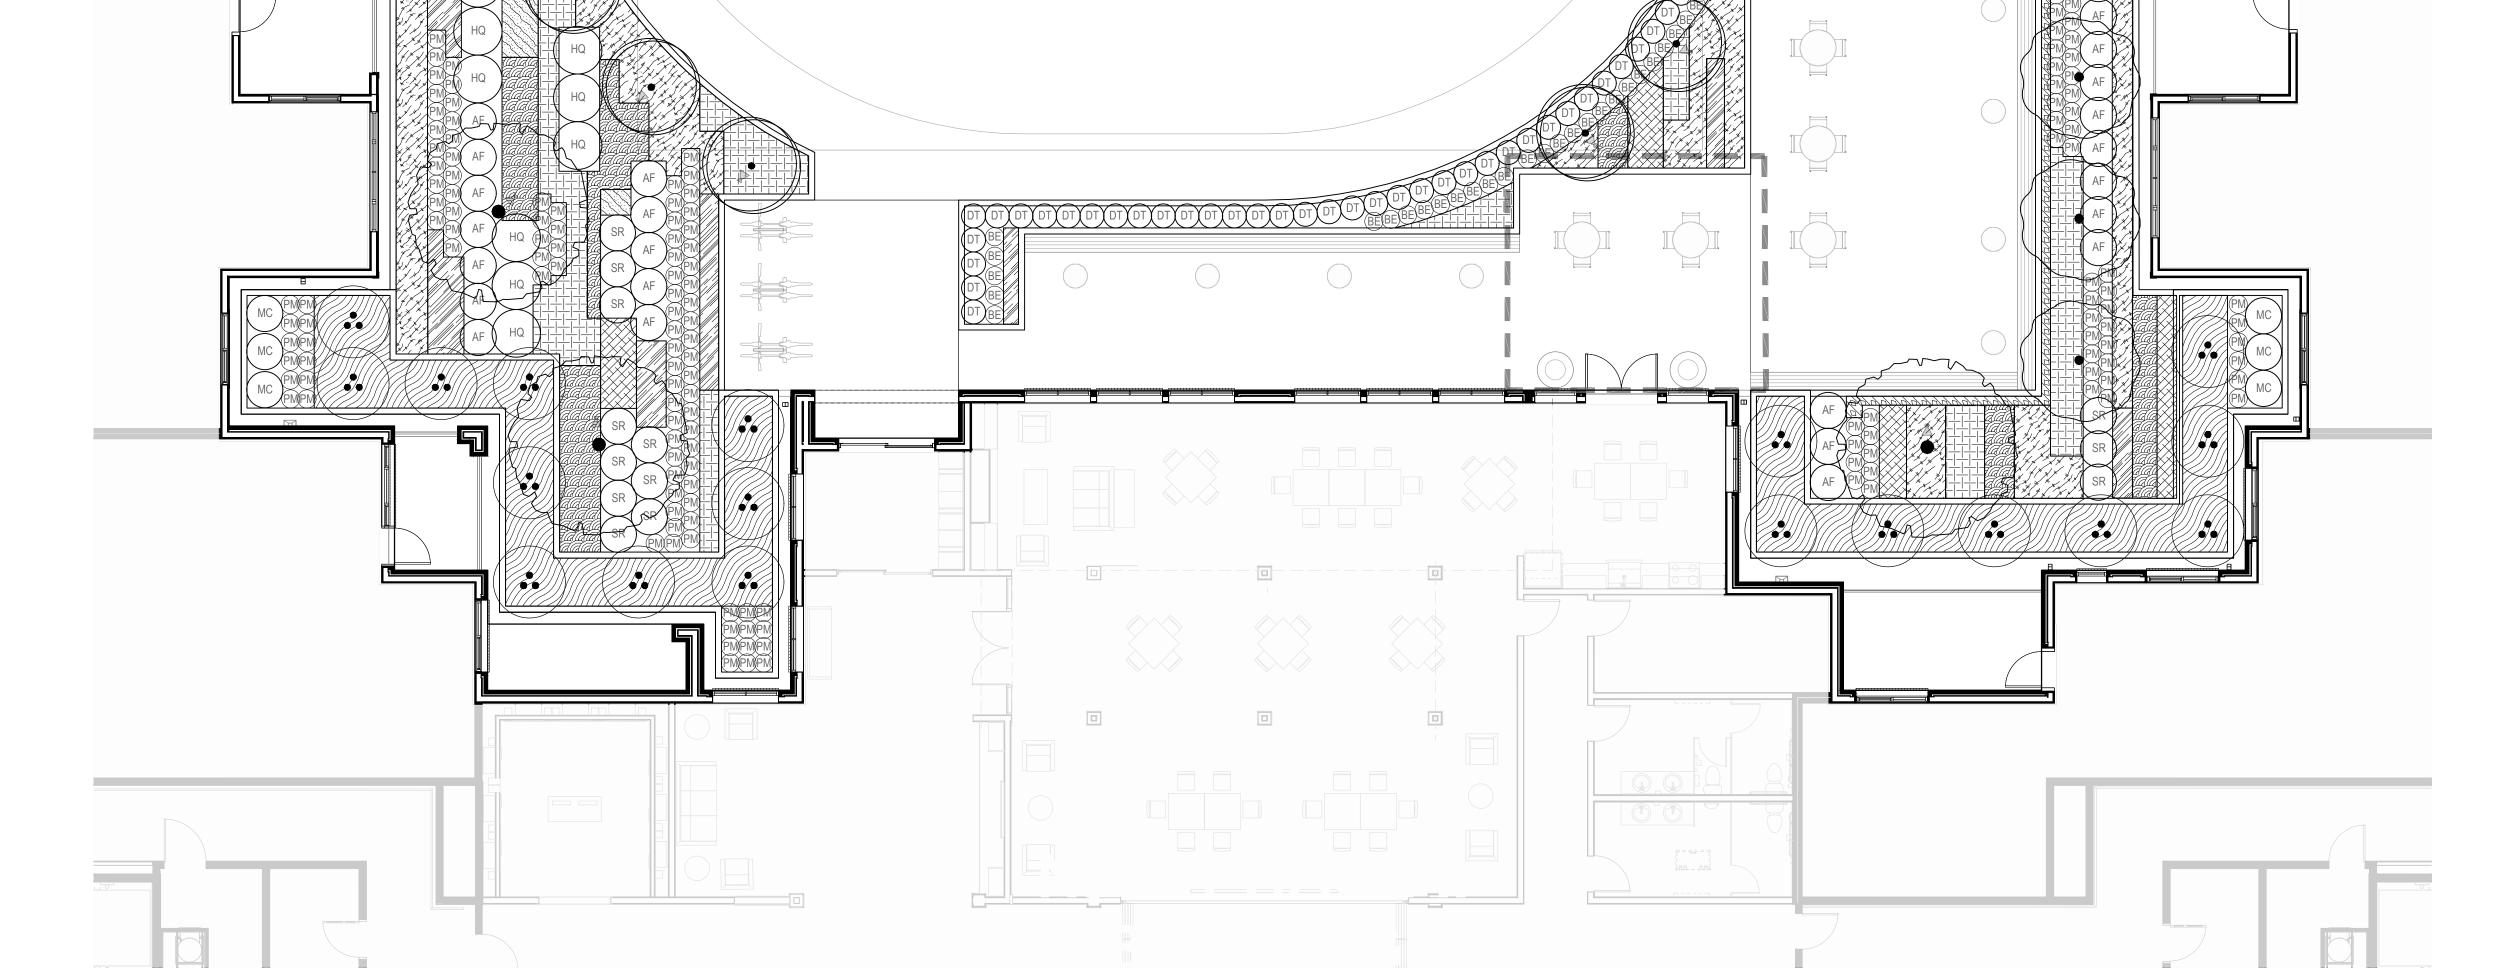

NORTH COURTYARD PLANTING PLAN ENLARGEMENT

STRUCTURE BELOW

SHEET:

L501

50% DD SET
07.30.20

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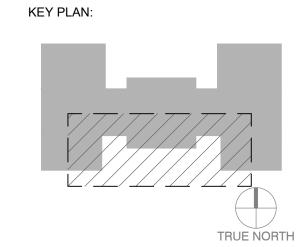
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Friendsview
RETIREMENT COMMUNITY

SHEET TITLE:
SOUTH
COURTYARD
PLANTING
PLAN
ENLARGEMENT

LEV DLAN



DRAWN BY: DATE CREATED:

0 8 16 24 32 feet 1/8" = 1'-0"

CONT CAL

SIZE HT.

5 GAL

3 GAL

5 GAL

5 GAL

3 GAL

1 GAL

SIZE HT.

SPACING

24" o.c.

SPACING

15" o.c.

18" o.c.


18" o.c.

12" o.c.

25 GAL 2" CAL 8-10` H

B & B 2" CAL 12-15` H

B & B MULTI-TRUNK 12-14` H

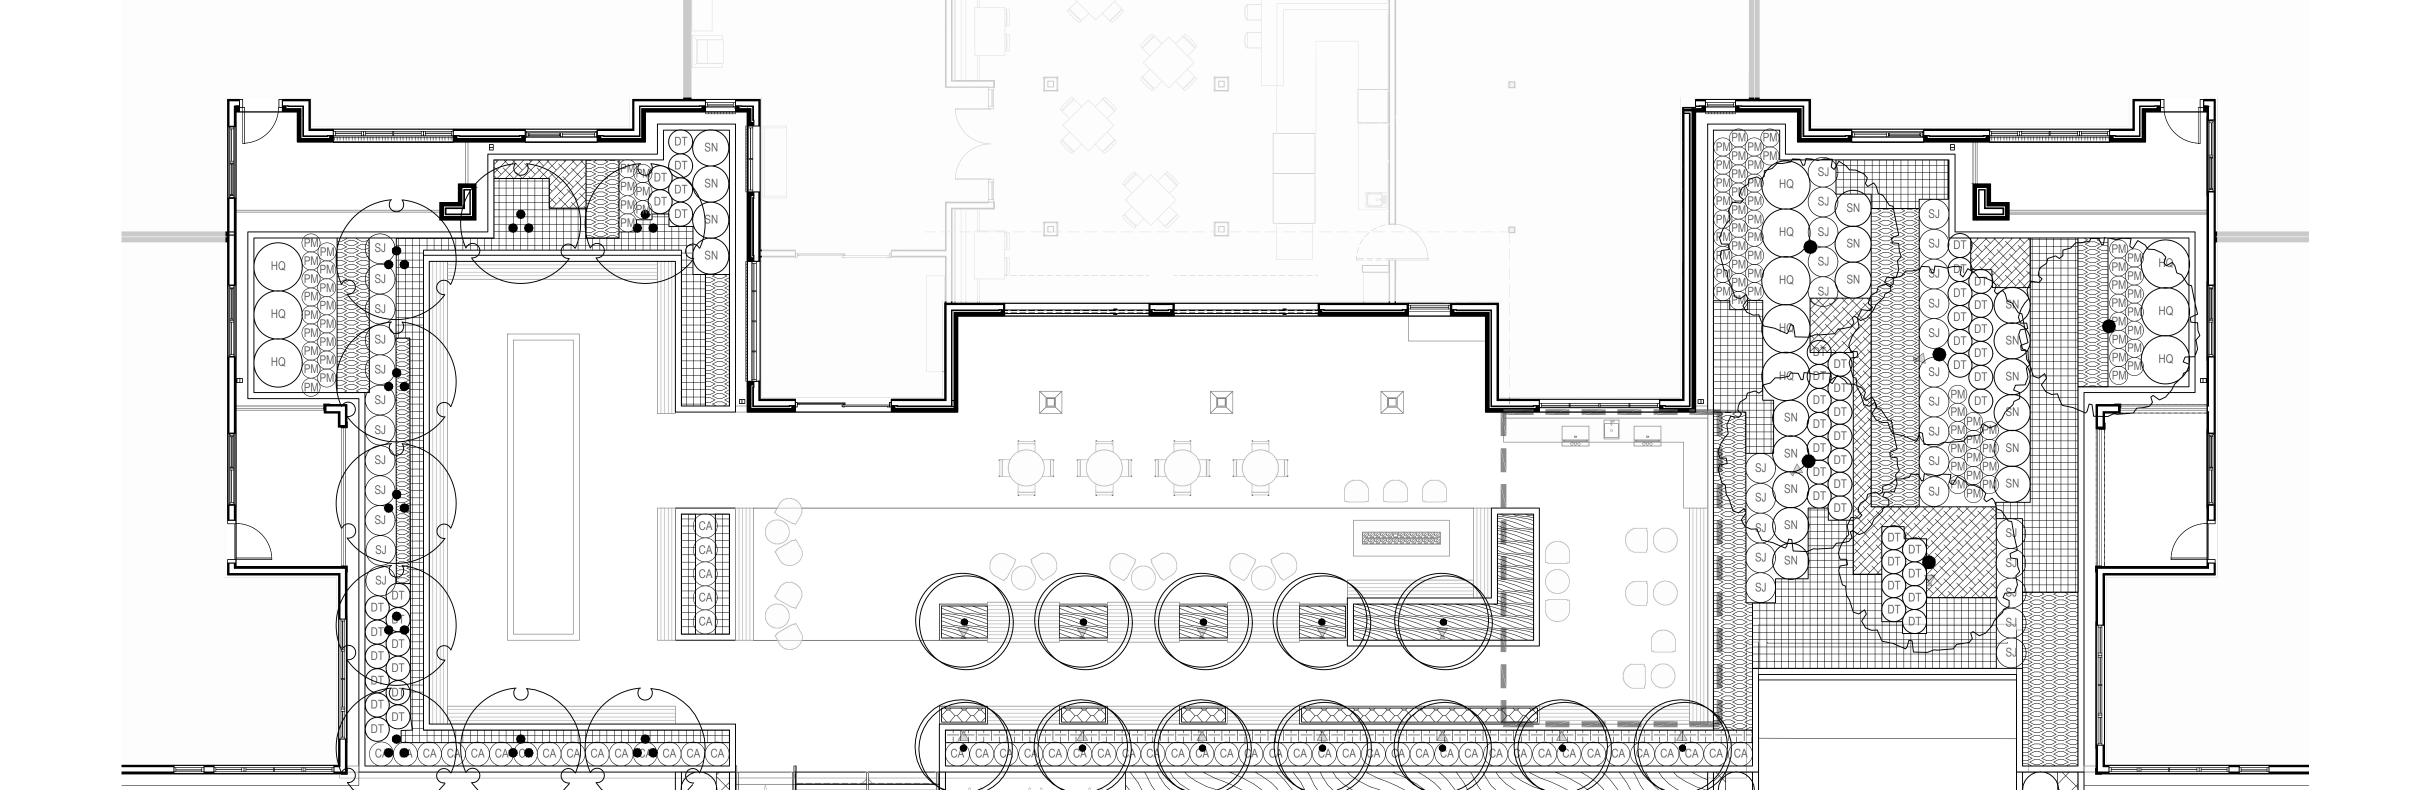

PLANT MIX SCHEDULE - SOUTH COURTYARD

PLANT GROUP A
IRIS TENAY (OREGON IRIS

PLANT SCHEDULE - SOUTH COURTYARD

CODE BOTANICAL / COMMON NAME

AP ACER PALMATUM 'SEIRYU'

CODE BOTANICAL / COMMON NAME

POLYSTICHUM MUNITUM WESTERN SWORD FERN

GOLDMOUND SPIREA

SNOWMOUND SPIREA

CODE BOTANICAL / COMMON NAME

CODE BOTANICAL / COMMON NAME

STAR JASMINE

DECE DESCHAMPSIA CESPITOSA TUFTED HAIR GRASS

GAUL GAULTHERIA SHALLON SALAL

LIMU LIRIOPE MUSCARI 'BIG BLUE' BIG BLUE LILYTURF

GROUND COVERS CODE BOTANICAL / COMMON NAME

SEIRYU JAPANESE MAPLE

CORNUS KOUSA X NUTTALLII `KN4-43` STARLIGHT KOUSA DOGWOOD

LAGERSTROEMIA X `NATCHEZ` MULTI-TRUNK WHITE CRAPE MYRTLE • LIMBED-UP 7 FT

HYDRANGEA QUERCIFOLIA `PEE WEE` OAKLEAF HYDRANGEA

SPIRAEA JAPONICA 'GOLDMOUND'

SPIRAEA NIPPONICA 'SNOWMOUND'

TRACHELOSPERMUM JASMINOIDES

DAPHNE X TRANSATLANTICA `ALBA EVERBLOOM` 3 GAL EVERBLOOM DAPHNE

CALAMAGROSTIS X ACUTIFLORA `KARL FOERSTER` 3 GAL FEATHER REED GRASS


ARUV ARCTOSTAPHYLOS UVA-URSI `MASSACHUSETTS` 1 GAL MASSACHUSETTS MANZANITA

PLANT GROUP A
IRIS TENAX / OREGON IRIS
PENNISETUM ALOPECUROIDES `HAMELN` / HAMELN DWARF FOUNTAIN GRASS 2 GAL 65% @ 18" oc

SOUTH COURTYARD PLANTING PLAN ENLARGEMENT





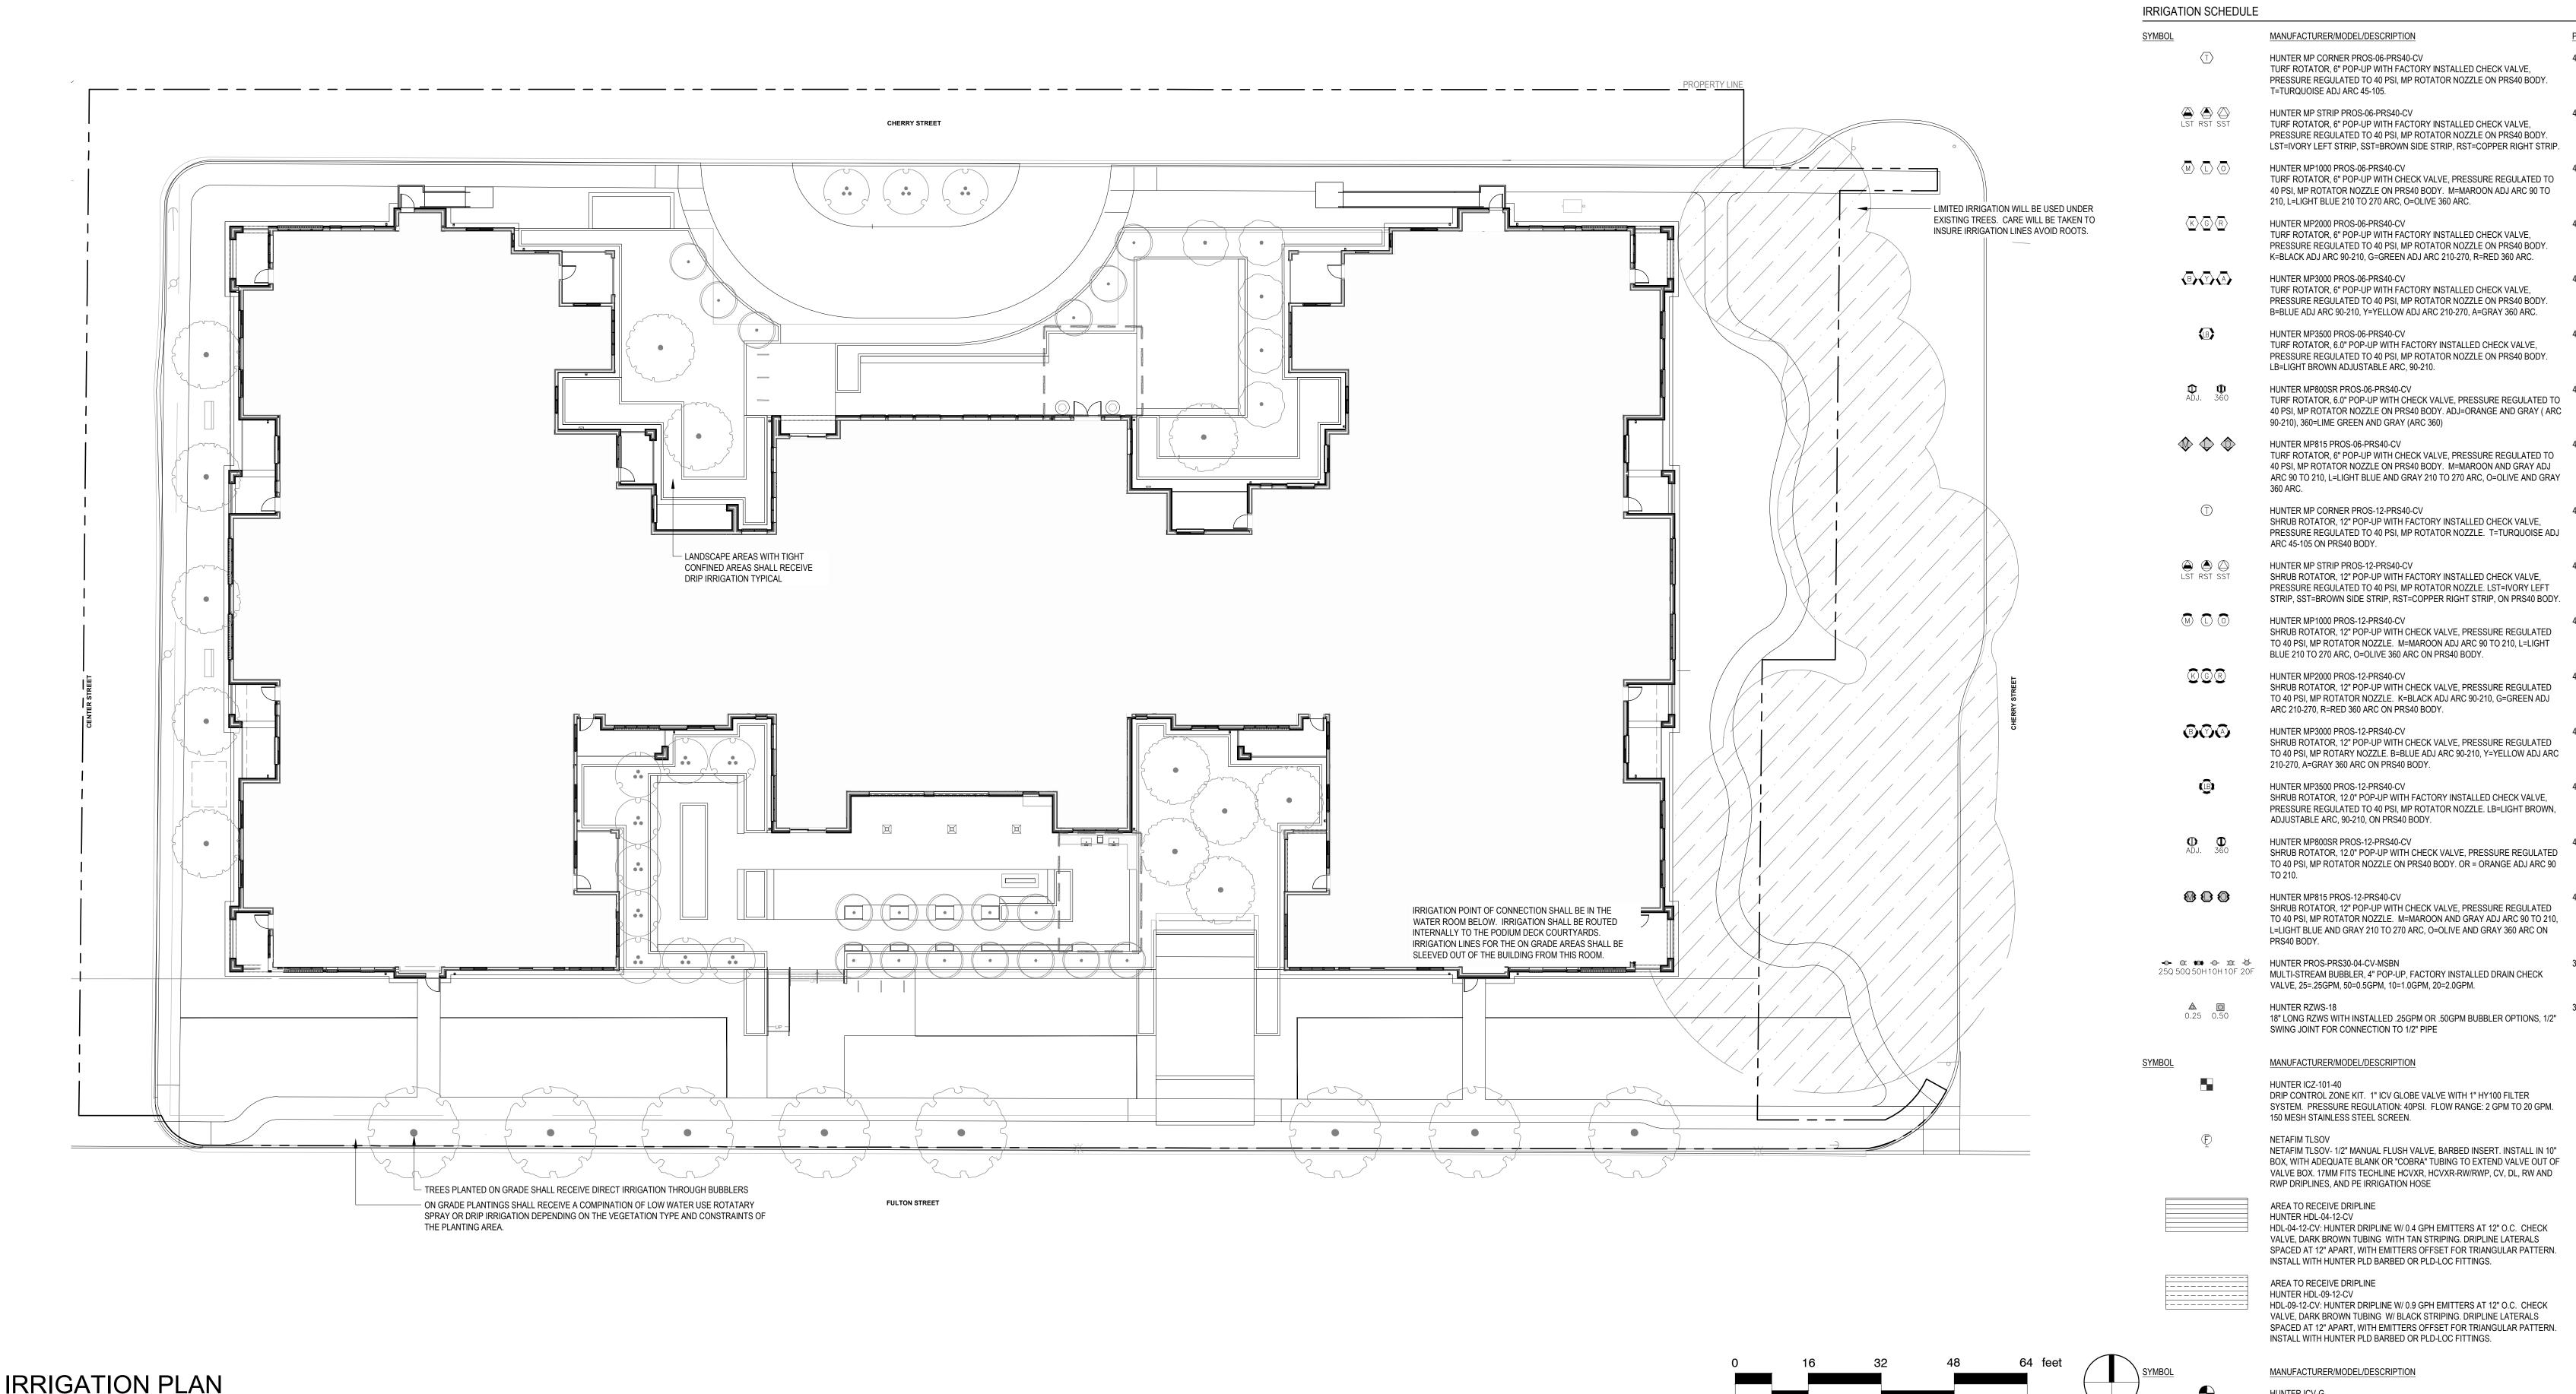

GENERAL IRRIGATION NOTES:

- A. ALL PLANTED AREAS TO BE IRRIGATED. WITH A PERMANENT AUTOMATIC IRRIGATION SYSTEM. IRRIGATION ZONES SHALL BE BROKEN UP INTO HYDROZONES BASED ON VEGETATION TYPE,
- PLANTING AREA, AND MICROCLIMATE. C. PLAN IS DIAGRAMMATIC. STAKE ALL VALVE BOX LOCATIONS FOR APPROVAL. SET VALVE BOXES SQUARE TO ADJACENT BUILDING, CURB, OR PAVING.
- D. ALL PIPE UNDER BUILDINGS, ROADS, WALKS, PARKING AREAS OR OTHER PAVED SURFACES SHALL BE SLEEVED, WHETHER SHOWN OR NOT. SLEEVES SHALL MINIMUM 4" DIAMETER, OR AS
- E. ALL PIPE OR EQUIPMENT SHOWN IN PAVING ADJACENT AND PARALLEL TO PLANTED AREAS IS INTENDED TO BE PLACED IN THAT AREA WHERE POSSIBLE. ALL MATERIAL TO BE INSTALLED ON OWNERS PROPERTY.

INDICATED. SLEEVING MAY BE INCLUDED FOR FUTURE WORK.

- F. MAKE ANY AND ALL REQUIRED ADJUSTMENTS TO THE IRRIGATION PLAN TO ASSURE COMPLETE AND ADEQUATE COVERAGE WITH MINIMUM OVERSPRAY.
- SEE PROJECT SPECIFICATIONS FOR ADDITIONAL INFORMATION.
- H. PROVIDE GATE VALVES AT POINTS OF CONNECTION GATE VALVES SHALL BE INSTALLED AT MINIMUM 12" DEPTH.
- I. LATERAL LINE SHALL HAVE 18" OF COVER, AND MAIN LINES 24". 36" MAXIMUM COVER UNDER ROADWAYS.
- J. REFER TO PLANTING AND LAYOUT PLANS FOR EXACT LAYOUT. INTENT IS THAT ALL NEW PLANTINGS RECEIVE ADEQUATE WATER.
- K. VERIFY STATIC PRESSURE AT POC AT COMMENCEMENT OF CONTRACT. PROVIDE POC PSI
- SUBMITTAL TO LANDSCAPE ARCHITECT PRIOR TO BEGINNING WORK. BACKFLOW INSTALLATION SHALL CONFORM TO LOCAL CODES FOR ASSEMBLY INSTALLATION REQUIREMENTS.

M. PROTECT AND PRESERVE SLAB MEMBRANE ON ROOF AND/OR IN PLANTERS.

PIPE SHOWN AT A LARGER SIZE ACCOUNTS FOR REDUCED FPS VELOCITY AND SHOULD BE FOLLOWED ZONES OF 7 GPM OR LESS SHALL USE 3/4" PIPE. WHEN PEX OR WIRSBO PIPING IS USED PIPE DIAMETER SHALL BE INCREASED BY A MIN. OF 1/2"

PIPE SIZE CHART SCHEDULE 40 PVC

MAXIMUM WATER VELOCITY 5 FEET PER SECOND

PIPE SIZE	GPM
3/4"	0 - 7
1"	7-12
1 1/4"	12- 22
1 1/2"	22 - 32
2"	32 - 52
2 1/2"	52 - 70
3"	70-110

1", 1-1/2", 2", AND 3" PLASTIC ELECTRIC REMOTE CONTROL VALVES, GLOBE CONFIGURATION, WITH NPT THREADED INLET/OUTLET, FOR NORTH COMMERCIAL/MUNICIPAL USE. **HUNTER ICV-G** 1", 1-1/2", 2", AND 3" PLASTIC ELECTRIC MASTER VALVE, GLOBE CONFIGURATION, WITH NPT THREADED INLET/OUTLET, FOR COMMERCIAL/MUNICIPAL USE. DOUBLE CHECK VALVE ASSEMBLY W/ EZSWAP INSERT. **HUNTER PHC-2400I** WI-FI ENABLED, FULL-FUNCTIONING CONTROLLER WITH TOUCHSCREEN, 24-STATION FIXED CONTROLLER, 120 VAC, INDOOR MODEL. HUNTER HC-200-FLOW 2" FOR USE WITH HYDRAWISE ENABLED CONTROLLER TO MONITOR FLOW

AND PROVIDE SYSTEM ALERTS. ALSO FUNCTIONS AS STAND ALONE FLOW

AVAILIBLE WATER PRESSURE IS CURRENTLY UNKNOWN

SYSTEM.

POINT OF CONNECTION 1-1/2"

TOTALIZER/SUB METER ON ANY RESIDENTIAL OR COMMERCIAL IRRIGATION

1/16" = 1'

PRELIMINARY

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CONSULTANT:

SHAPIRO / DIDWAY

1204 SE Water Ave Portland, Oregon 97214 t. 503.232.0520 www.shapirodidway.com

PROJECT NUMBER: University Village Phase II (Building #1)

1001 Fulton Street, Newberg, OR 97132




SHEET TITLE: IRRIGATION PLAN

KEY PLAN:



TRUE NORTH

DRAWN BY: DATE CREATED:

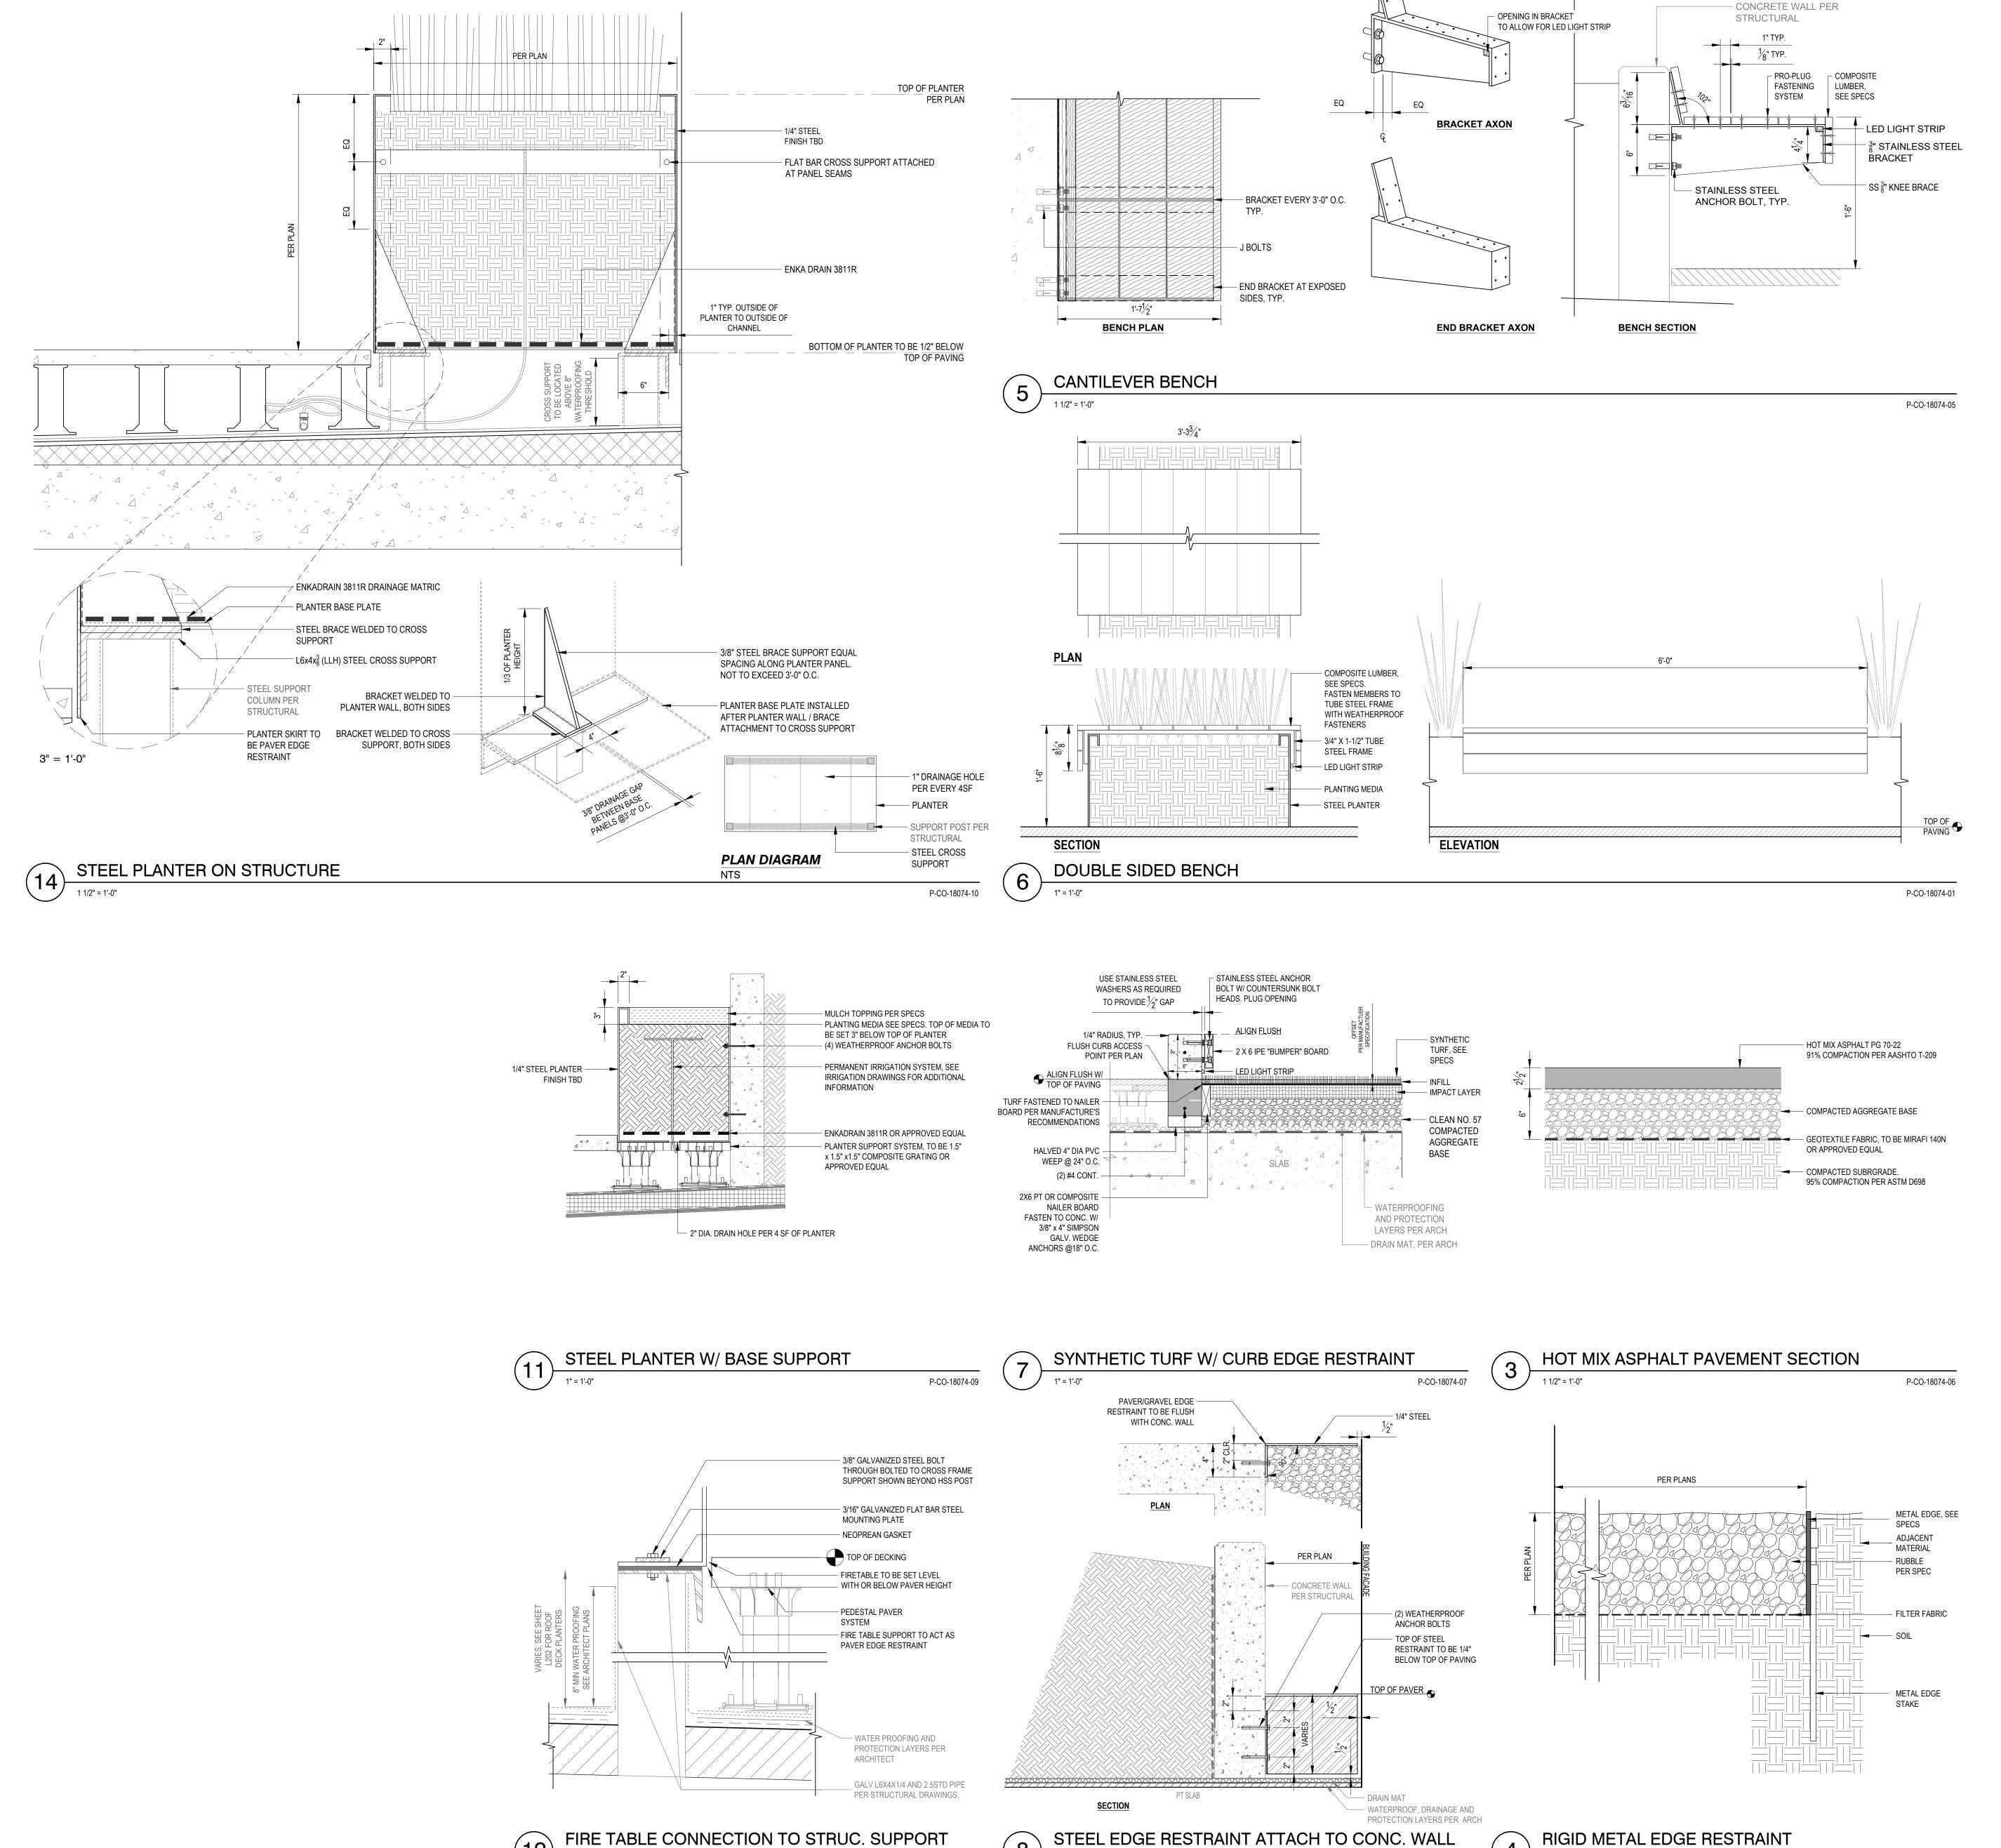

P-CO-18074-08

ARCHITECTS

720 NW Davis 503.221.1121 Suite 300 503.221.2077 Portland OR 97209 www.lrsarchitects.com

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CONSULTANT:

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University
Village Phase II
(Building #1)

1001 Fulton Street, Newberg, OR 97132

Friendsview
RETIREMENT COMMUNITY

SHEET TITLE:

LANDSCAPE

CONSTRUCTION

DETAILS

DRAWN BY: DATE CREATED:


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TREE PROTECTION NOTES

- OWNER SHALL RETAIN A CERTIFIED ARBORIST. ALL REFERENCES WITHIN THIS DOCUMENT REFER TO THE OWNER'S CERTIFIED ARBORIST.
- ALL TREES WILL NEED TO BE EVALUATED AND TAGGED FOR PRESERVATION OR DEMOLITION BY THE OWNER'S CERTIFIED ARBORIST. THE PROJECT ARCHITECT AND OWNER'S CERTIFIED ARBORIST SHALL BE NOTIFIED IF ANY DISCREPANCIES ARE FOUND WITH THE TREES IDENTIFIED ON THIS PLAN AND ACTUAL CONDITIONS.

FENCING PROTECTION ZONE

ALL ZONES

- 1. PROTECTIVE FENCING SHALL BE PROVIDED AND MAINTAINED AT THE DRIP LINE OF EACH TREE OR GROUP OF TREES AT THE DRIP LINE. ORANGE OR GREEN PVC WEB FENCING MAY BE USED ONLY AS APPROVED BY THE CITY AND OWNER. ZONE C FENCING BEYOND THE DRIP LINE IS NOT REQUIRED BUT IS RECOMMENDED WHERE POSSIBLE.
- 2. THE APPROVAL OF THE OWNER'S CERTIFIED ARBORIST IS REQUIRED FOR USE/ACCESS WITHIN ZONES.
- 3. SURFACE PROTECTION MEASURES REQUIRED SUCH AS WOOD PLANKING OR STEEL PLATES UNDER BACKHOE STABILIZERS PLACED ANYWHERE WITHIN ZONES. 4. BARK MULCH REQUIRED AT 6"-8" DEPTH KEPT 12 INCHES CLEAR OF TRUNK.
- 5. NO MATERIALS, EQUIPMENT, SPOIL, OR WASTE OR WASHOUT / WASTEWATER I.E. CEMENT MAY BE DEPOSITED, STORED, OR PARKED WITHIN THE TREE PROTECTION ZONE C AT ALL TIMES. 6. PROVIDING SEASONAL WATERING AS NEEDED TO MAINTAIN HEALTH AND VIGOR OF PLANTS TO REMAIN. THIS INCLUDES PROVIDING WATER SUPPLY, PIPING AND HOSES, AND APPLICATION MATERIALS AND THE LABOR REQUIRED TO PROVIDE PROPER WATER APPLICATION.

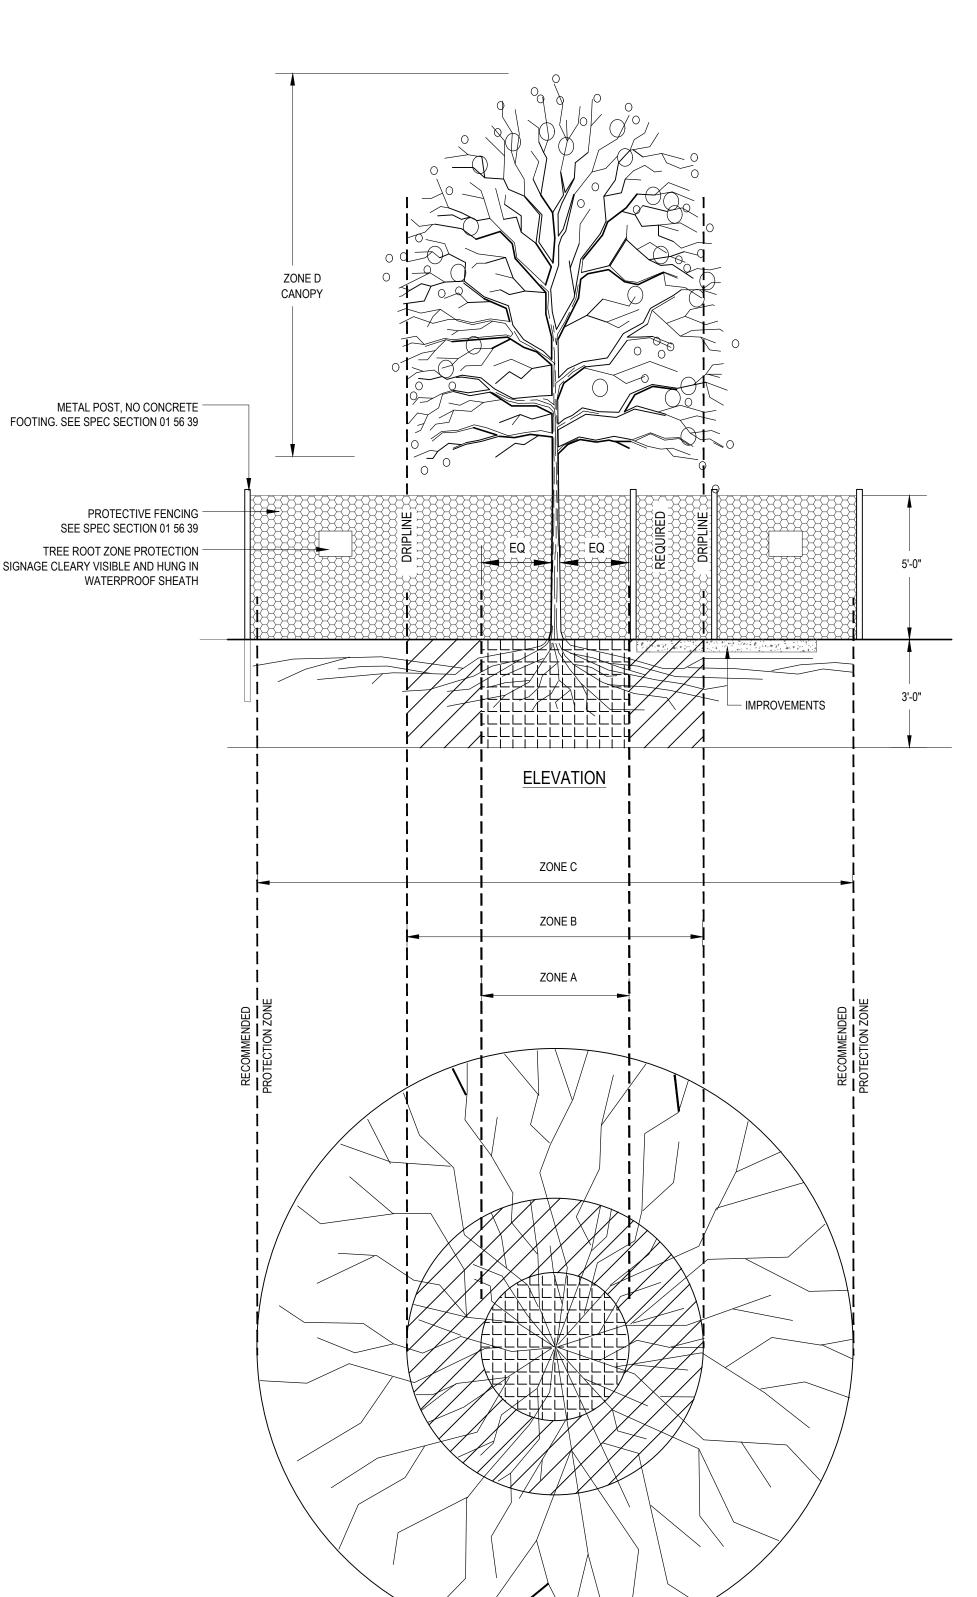TRENCHING / EXCAVATION

[(CRZ) IS DETERMINED BY TRUNK DIAMETER MEASURED AT CHEST HEIGHT (DBH) AND CRZ IS EQUAL TO 1-FOOT RADIUS FOR EVERY 1" DIAMETER OF TREE.]

- 1. NO DISTURBANCE ALLOWED WITHOUT SITE-SPECIFIC INSPECTION AND APPROVAL OF METHODS TO MINIMIZE ROOT DAMAGE
- 2. SEVERANCE OF ROOTS LARGER THAN 2 INCHES IN DIAMETER REQUIRES THE OWNER'S CERTIFIED ARBORIST APPROVAL.
- 3. TUNNELLING REQUIRED TO INSTALL LINES 3 FEET BELOW GRADE OR DEEPER 4. ALL NON-PAVED SURFACES IN ZONE SUBJECT TO IMPACT (COMPACTION) BY CONSTRUCTION ACTIVITIES SHALL BE PROTECTED WITH THE ABOVE STATED OPTIONS FOR SURFACE PROTECTION MEASURES.

ZONE B (DRIPLINE)

[DEFINED AS MAXIMUM WIDTH OF BRANCH EXTENSION ON TREE]


- 1. OPERATION OF HEAVY EQUIPMENT AND/OR STOCKPILING OF MATERIALS SUBJECT TO THE OWNER'S CERTIFIED ARBORIST APPROVAL.
- 2. MAINTAIN 2/3 OR MORE OF ZONE IN UNDISTURBED CONDITION. 3. WHEN TRENCHING FOR UTILITIES WITHIN ZONE B, HAND DIG OR TUNNEL AROUND ROOTS WHENEVER POSSIBLE. CUT ALL ROOTS CLEANLY WITH SHARP PRUNERS OR SAWS. IF ROOTS OVER 2" DIA. ARE ENCOUNTERED, NOTIFY OWNER'S AUTHORIZED REPRESENTATIVE. FOR INSPECTION AND APPROVAL PRIOR TO PROCEEDING. ROOT PRUNE AND REMEDY ONLY AS DIRECTED BY THE OWNER'S CERTIFIED
- 4. AIR OR WATER-SPADING, OR BORING MAY BE REQUIRED BY IN ZONE A OR ZONE B IF CONDITIONS WARRANT. 5. FOR INSTALLATION OF SILT FENCING, DO NOT TRENCH IN ZONE A OR ZONE B; INSTEAD SECURE TOE OF FENCING WITH DRAIN ROCK OR SUITABLE SOIL AND MONITOR/MAINTAIN FENCING AS NECESSARY
- TO PREVENT EROSION. 4. ALL NON-PAVED SURFACES IN ZONE SUBJECT TO IMPACT (COMPACTION) BY CONSTRUCTION ACTIVITIES SHALL BE PROTECTED WITH THE ABOVE STATED OPTIONS FOR SURFACE PROTECTION MEASURES.

ZONE C (ABSORBING ROOT ZONE) [(ARZ) IS DETERMINED BY TRUNK DIAMETER MEASURED AT CHEST HEIGHT (DBH) AND ARZ IS EQUAL TO 2-FOOT RADIUS FOR EVERY 1" DIAMETER OF TREE.]

- 1. OPERATION OF HEAVY EQUIPMENT AND OR STOCKPILING OF MATERIALS SUBJECT TO OWNER'S AUTHORIZED REPRESENTATIVE APPROVAL. 2. TRENCHING WITH HEAVY EQUIPMENT ALLOWED AS FOLLOWS:
- MINIMIZE TRENCH WIDTH - MAINTAIN 2/3 OR MORE OF ZONE IN UNDISTURBED CONDITION
- 3. ALL NON-PAVED SURFACES IN ZONE SUBJECT TO IMPACT (COMPACTION) BY CONSTRUCTION ACTIVITIES SHALL BE PROTECTED WITH THE ABOVE STATED OPTIONS FOR SURFACE PROTECTION

ZONE D (CANOPY)

1. OVERHEAD BRANCHING LIKELY TO BE DAMAGED BY EQUIPMENT OPERATION SHALL BE BROUGHT TO THE ATTENTION OF THE OWNER'S CERTIFIED ARBORIST. OVERHEAD PREVENTIVE MEASURES (PRUNING OR TIE-BACK OF BRANCHES) AS APPROVED BY THE OWNER'S CERTIFIED ARBORIST SHALL BE PROPERLY EXECUTED BEFORE COMMENCEMENT OF THE CONSTRUCTION ACTIVITIES. 2. WASH OFF FOLIAGE WHICH BECOMES SOILED DURING CONSTRUCTION.

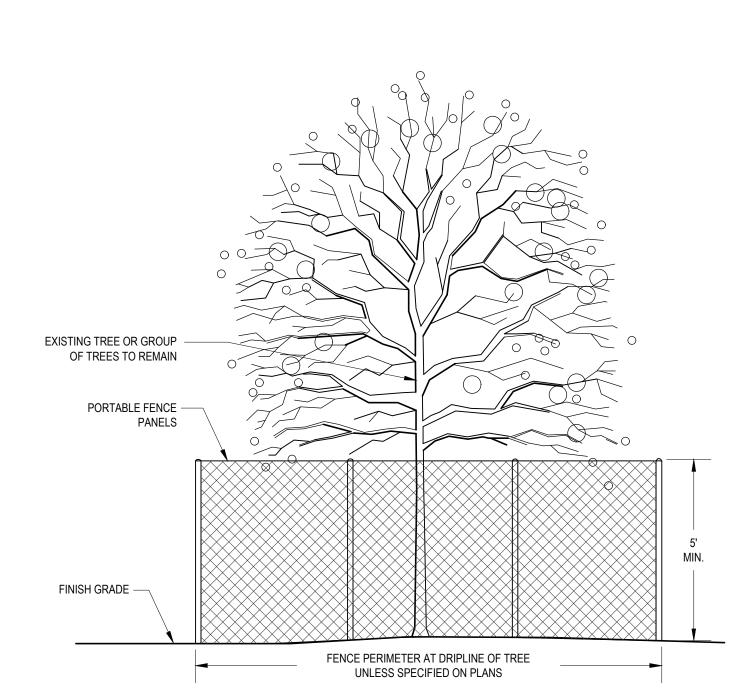

EXISTING TREE PROTECTION

GENERAL SITE NOTES:

PLAN

- ALL WORK WITHIN THE PUBLIC RIGHT OF WAY UNDER SEPARATE PERMIT. SHOWN FOR REFERENCE ONLY. REFER TO APPROVED RIGHT OF WAY DRAWINGS PRIOR TO CONSTRUCTION.
- REFERENCE CIVIL AND ARCHITECTURAL DRAWINGS FOR ADDITIONAL SITEWORK INFORMATION

PLANTING NOTES:

DO NOT WILLFULLY PROCEED WITH PLANTING OPERATIONS WHEN IT IS OBVIOUS THAT UNKNOWN OBSTRUCTIONS AND GRADE DIFFERENCES EXIST THAT MAY NOT HAVE BEEN KNOWN THE DURING DESIGN PROCESS. BRING SUCH CONDITIONS IMMEDIATELY TO ATTENTION OF OWNER'S AUTHORIZED REPRESENTATIVE FOR RESOLUTION. ASSUME FULL RESPONSIBILITY FOR COSTS INCURRED AND REQUIRED MODIFICATIONS DUE TO LACK OF PROVIDING SUCH NOTIFI CATION.

ENSURE THAT FINISH GRADE ELEVATIONS OF PLANTING AREAS ARE SET AT THE PROPER ELEVATIONS RELATIVE TO PAVING FINISH SURFACE ELEVATIONS, UTILITY COVERS AND CURBS. SHRUBS PLANTING AREAS AT 2" BELOW AND LAWN 1" BELOW ADJACENT GRADE. NOTIFY OWNER OF ANY DISCREPANCIES.

ASSURE POSITIVE DRAINAGE IN ALL PLANTING AREAS TO DRAIN AWAY FROM BUILDING, 2% MINIMUM.

PLANT MATERIAL, I.E. TREES, SHRUBS VINES, ESPALIERS AND GROUNDCOVERS, MUST BE APPROVED BY OWNER'S AUTHORIZED REPRESENTATIVE PRIOR TO INSTALLATION. PLANT MATERIAL INSTALLED WITHOUT OWNER'S AUTHORIZED REPRESENTATIVE'S APPROVAL MAY BE SUBJECT TO REMOVAL AND REPLACEMENT WITH RELATED COSTS BORNE BY CONTRACTOR.

FINAL LOCATIONS OF PLANT MATERIALS ARE SUBJECT TO APPROVAL OF THE OWNER'S AUTHORIZED REPRESENTATIVE PRIOR TO INSTALLATION. PERFORM THE FOLLOWING BEFORE BEGINNING PLANTING PIT EXCAVATION:

A. SHRUBS - PLACE ACTUAL PLANT CONTAINERS ON-SITE IN "FINAL" LOCATIONS.

B. TREES - CHALK OR STAKE CENTER OF TREE.

PLANTING SHALL NOT BE PERFORMED UNTIL PRE-PLANTING SOIL AMENDMENTS ARE COMPLETE AND APPROVED BY THE OWNER'S REPRESENATIVE

IF CONFLICTS ARISE BETWEEN ACTUAL SIZE OF PLANTING AREAS ON-SITE AND THOSE AREAS INDICATED ON DRAWINGS, CONTACT OWNER'S AUTHORIZED REPRESENTATIVE FOR RESOLUTION. FAILURE TO MAKE SUCH CONFLICTS KNOWN TO OWNER'S AUTHORIZED REPRESENTATIVE IN A TIMELY FASHION MAY RESULT IN CONTRACTOR'S LIABILITY TO RELOCATE PLANT MATERIALS OR AT WORST CASE, BECOME UNABLE TO CHARGE OWNER FOR PLANT MATERIAL ALREADY PLANTED.


SHRUB AND GROUNDCOVER AREAS TO RECIEVE A 2-INCH DEEP LAYER MULCH TO BE SUBMITTED FOR APPROVAL FROM LANDSCAPE ARCHITECT.

AN AUTOMATIC IRRIGATION SYSTEM IS TO BE INSTALLED WITHIN ALL PLANTING AREAS PROVIDING HEAD TO HEAD COVERAGE.

PROVIDE ROOT CONTROL BARRIERS FOR ALL TREES PLANTED WITHIN 5' OF A HARDSCAPE EDGE SUCH AS PAVING, WALLS, STEPS, ETC. REFER TO PLANTING DETAILS FOR ADDITIONAL INFORMATION.

INSTALL PLANT MATERIAL WITH ITS BEST SIDE FACING PREDOMINATE VIEW OF PUBLIC.

PROVIDE THE PROPER SETBACK BETWEEN UTILITIES AND TREES - CONTACT CITY INSPECTOR FOR REQUIRED SETBACKS IN THE CASE THAT THE DRAWINGS ARE NOT CLEAR.

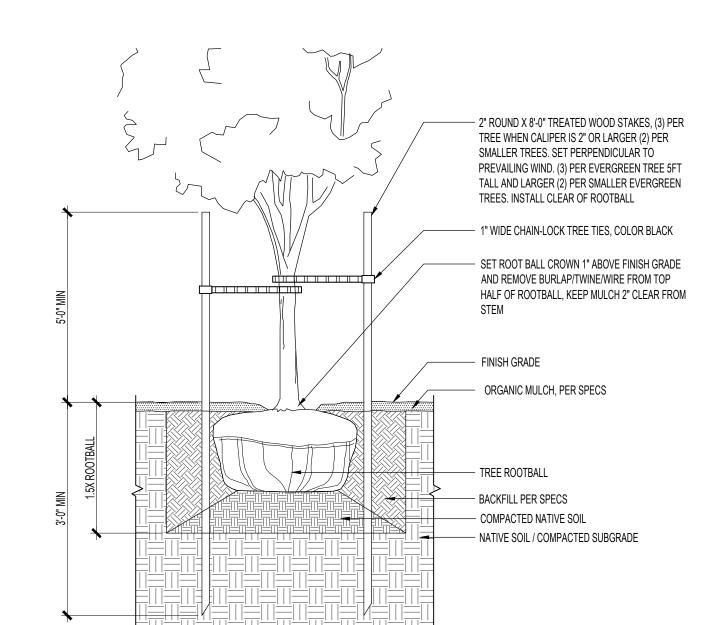

TREE PLANTING ON GRADE

GALVANIZED TURNBUCKLE

SECTION

2-3" DARK BARK DUST

PLANTING AREA

4. PLANTING BEDS SHALL RECEIVE 3" OF DARK BARK DUST.

1. SUBSOIL SHALL BE SCARIFIED (TILLED) 4 " BELOW AMENDMENT LAYER. EXCEPT WHERE SCARIFICATION WOULD

PLANTING ARES SHALL HAVE COMPOST TILLED TO A DEPTH OF 8" INTO EXISTING OR SPECIFIED SOILS.

DAMAGE TREE ROOTS OR AS DETERMINED BY LANDSCAPE ARCHITECT OR ARBORIST.

3. TURF AREAS SHALL HAVE COMPOST AND SANDY LOAM TILLED TO A DEPTH OF 6".

SOIL AMENDMENT AND DEPTH

3" GARDEN COMPOST-

TILLED INTO 5 INCHES OF

SITE SOILS, OR SANDY

LOAM AS DIRECTED

MULCH AREA

AT GRADE WITH

ADJACENT SURFACING

NOTES:

AMENDED AS DESCRIBED.

WIRE ROPE -

`—*----*/ **ENLARGEMENT**

TOP OF MULCH LAYER.

GALVANIZED TURNBUCKLE

WOOD 2X4 HOLD DOWN (2) LOCATIONS WITH DRILLED 1/4 HOLE TO RECEIVE WIRE ROPE.

DEADMAN 2"X6"X4' WOOD TIMBER NON PRESSURE TREATED (2 PER

WIRE ROPE WRAPPED/TIED AROUND DEADMAN

LIGHTWEIGHT SOIL MIX PER SPECIFICATIONS.

WIRE ROPE W/LAG EYEBOLTS CENTERED ON DEADMAN

FINISHED GRADE WITH 2" MULCH

DEADMAND WOOD TIMBER

PER ARCHITECTS DRAWINGS.

SOIL AND COMPACTION PER SPECIFICATIONS

INTO 4" OF SANDY LOAM

TURF AREA

SITE SOILS SCARIFIED 4" BELOW

- STRUCTURAL SLAB

NON-WOVEN GEOTEXTILE FABRIC

REMOVE WIRE BASKET. REMOVE BURLAP AND

TWINE FROM TOP 1/3 OF BALL AND REMOVE ALL TWINE AROUND BASE OF TREE TRUNK TO

 1 PART COMPOST AS SPECIFIED SEE CHART PERMAMATRIX POUNDS REQUIRED (DRY) CALIPER SIZE 1.0" 5.00 1.5" 2.0" 10.00 2.5" 20.00 30.00 3.0" 3.5" 50.00

TREE BACKFILL AMENDED AS FOLLOWS: 3 PARTS OF EXISTING TOPSOIL


SHRUB, GRASSES AND GROUNDCOVER BACKFILL AMENDED AS FOLLOWS:

3 PARTS OF EXISTING TOPSOIL 1 PART COMPOST AS SPECIFIED SEE CHART

7,6 5, 25,1125 522 51,7,11				
CONTAINER SIZE	PERMAMATRIX POUNDS REQUIRED (DRY)			
PLUG	.05			
4-INCH	.20			
1 GAL.	.50			
2 GAL.	.75			
3 GAL.	1.25			
6 GAL.	1.50			
15 GAL.	5.00			


PERMAMATRIX AVAILABLE LOCALLY FROM SUNMARK



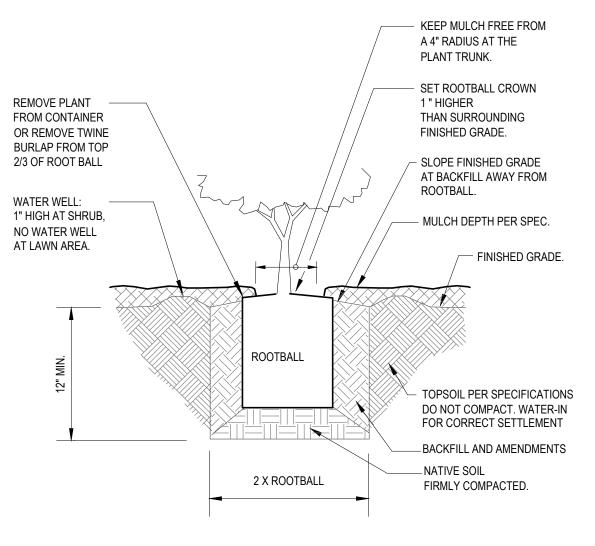


NOTE: CHECK ROOTBALL FOR PRESENCE OF ROOT FLARE AT BASE OF TRUNK. REMOVE EXCESS SOIL OVER ROOT FLARE AND ADJUST DEPTH OF PLANTING HOLE TO ACCOMODATE REDUCED ROOTBALL DEPTH IF NEEDED. ROOT FLARE MUST BE VISIBLE ABOVE MULCH/SOIL/ROOTBALL.



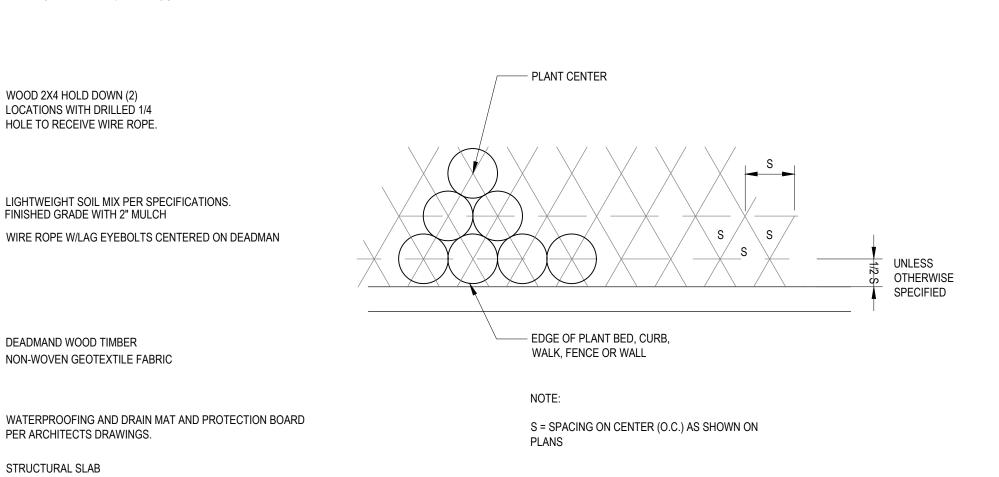



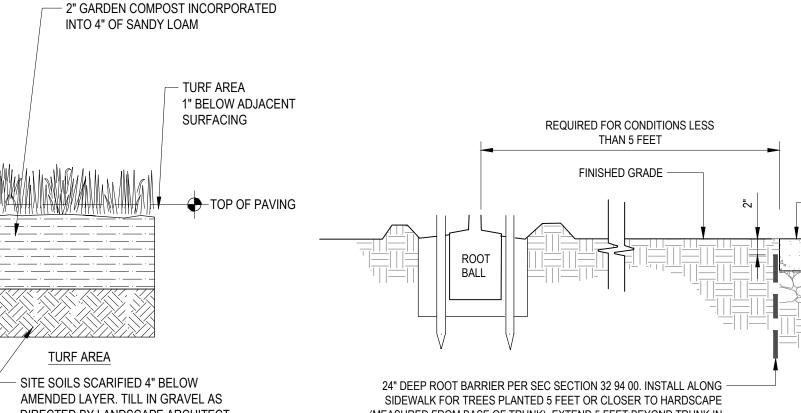

AMENDED LAYER. TILL IN GRAVEL AS DIRECTED BY LANDSCAPE ARCHITECT. ALL SOIL AREAS DISTURBED OR COMPACTED DURING CONSTRUCTION AND NOT COVERED BY BUILDINGS SHALL BE

(MEASURED FROM BASE OF TRUNK). EXTEND 5 FEET BEYOND TRUNK IN EACH DIRECTION, UNLESS NOTED OTHERWISE ON PLANS. IF LENGTHS ARE NOT SPECIFIED REFER TO MANUFACTURER'S RECOMMENDATIONS

ARCHITECTS 720 NW Davis 503.221.1121 🛣 Suite 300 503.221.2077 Portland OR 97209 www.lrsarchitects.com

> **PRELIMINARY NOT FOR CONSTRUCTION**

CONSULTANT:

329110-01

Portland, Oregon 97214 t. 503.232.0520 www.shapirodidway.com

PROJECT NUMBER: University Village Phase II (Building #1)

1001 Fulton Street, Newberg, OR 97132



SHEET TITLE: **PLANTING DETAILS**

DRAWN BY:


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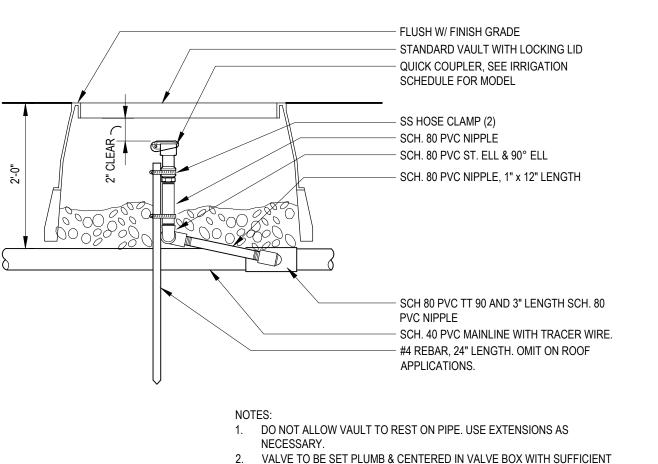
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SIDEWALK

DATE CREATED:

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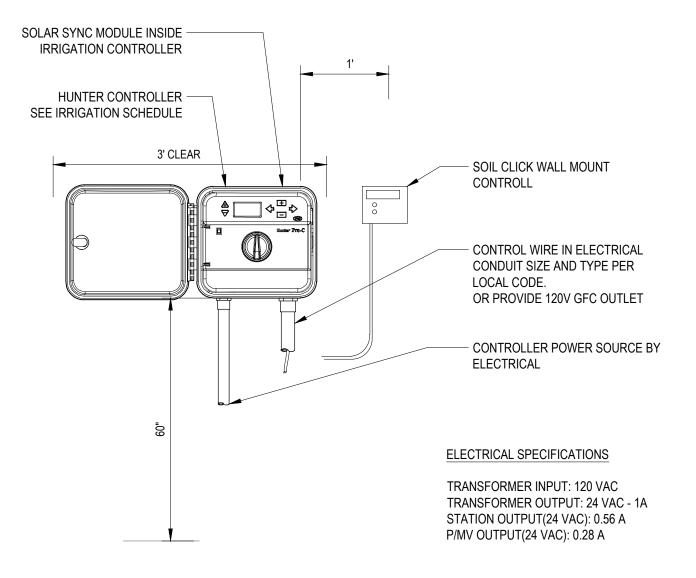


ROOM TO SWING KEY.

3284-10

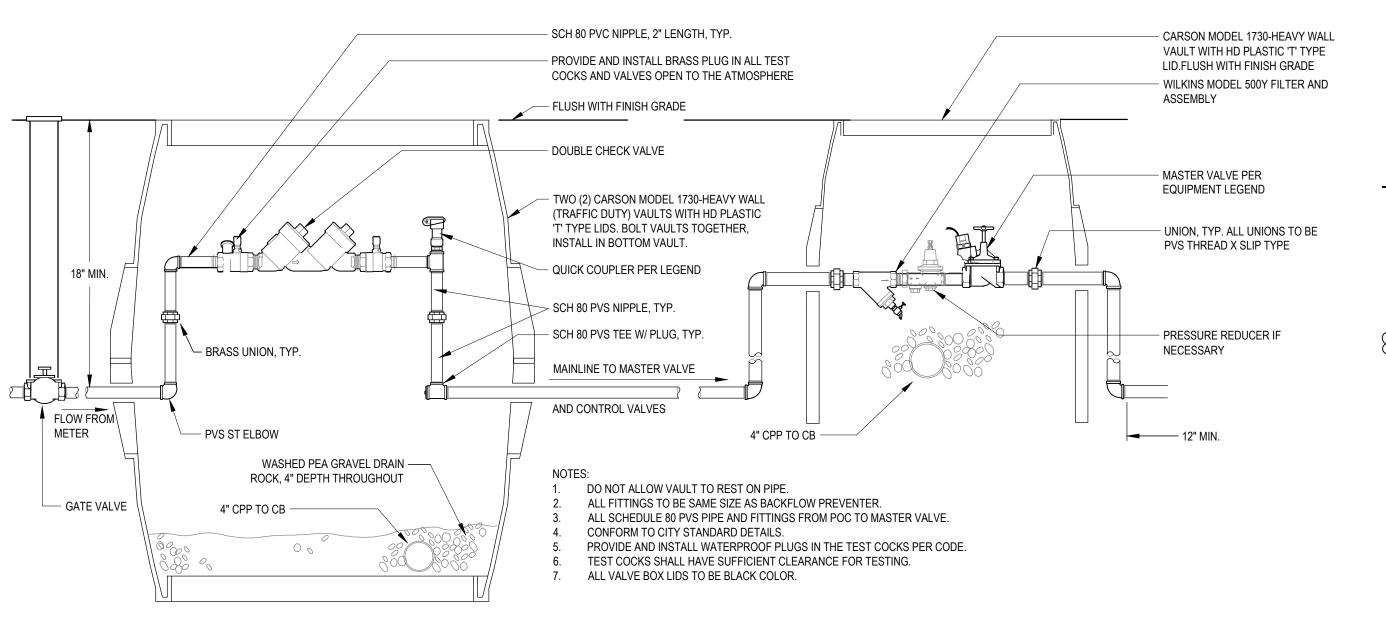4. PROVIDE 6" DEPTH DRAIN ROCK.

3. CONTRACTOR TO PROVIDE (2) EACH QCV KEYS AND SWIVEL HOSE ELLS.



IRRIGATION CONTROLLER WITH SOIL SENSOR

UTILITY AND IRRIGATION SLEEVING

JUNIBU

12"

LEGEND

1. RECTANGULAR SPECIFICATION GRADE

ALL LIDS TO BE BLACK IN COLOR
 QUICK COUPLER VALVE BOX, TYP.

PARALLEL TO PAVING

SAWCUT EXIST. PAVEMENT (TYP.) —

PAVEMENT OR PAVEMENT PATCH —



PRELIMINARY **NOT FOR** CONSTRUCTION

CONSULTANT:

328409-19

— ALL BACKFILL SHALL BE SAND OR APPROVED

NATIVE MATERIAL COMPACTED TO STANDARD FOR USE UNDER ROAD WAYS

1. ALL IRRIGATION SLEEVES TO BE

2. SLEEVES REQUIRED UNDER ALL

SLEEVE TO EXTEND 12" BEYOND

4. PROVIDE MULTIPLE SLEEVES AS

5. PROVIDE MINIMUM OF ONE SLEEVE

6. FOR PIPE LARGER THAN 2" THE

AND MARKING TAPE.

EDGE OF PAVING ON BOTH SIDES.

REQUIRED FOR ALL IRRIGATION

PIPES, WIRES, AND OTHER UTILITIES.

UNDER ANY CONCRETE AREAS NOT

INDICATED ON PLAN DRAWINGS

SLEEVES SHALL BE AT LEAST 2

O.D. SIZE OF INSERTED PIPES

PROVIDE A SEPARATE 2" SCH.80

ELECTRICAL CONDUIT FOR IRRIGATION CONTROL WIRES UNDER PAVEMENT

TIMES GREATER THAN THE TOTAL

CAP AND MARK WITH WOOD STAKES

CLASS 200 PVC

PAVED AREAS

Portland, Oregon 97214 t. 503.232.0520 www.shapirodidway.com

PROJECT NUMBER: University Village Phase II (Building #1)

1001 Fulton Street, Newberg, OR 97132

Friendsview
RETIREMENT COMMUNITY


SHEET TITLE: IRRIGATION **DETAILS**

DRAWN BY:


DATE CREATED:

328406-05 1. DO NOT ALLOW VAULT TO REST ON PIPE. 2. ALL PIPE WITHIN VAULT TO BE SCH 80 PVC NIPPLES, SAME SIZE AS CONTROL VALVE.


3. ALL BOLT COVERS TO BE LOCKING TYPE, BOLT INSTALLED. - SCH 80 PVC UNION, TYPICAL - AUTOMATIC CONTROL VALVE - VAULT FLUSH W/ FINISH GRADE CARSON JUMBO VALVE BOX VAULT TO EXTEND MINIMUM 6"

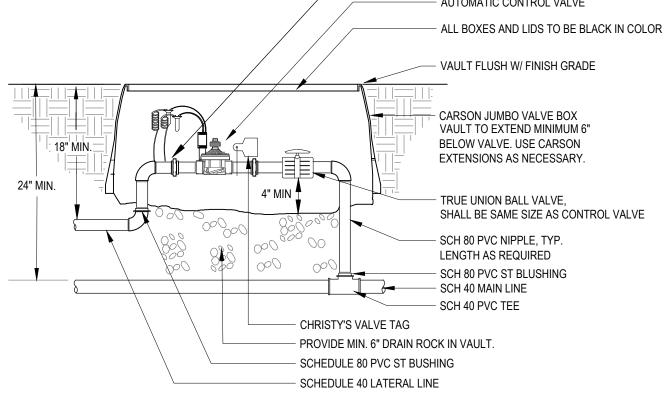


QUICK COUPLER VALVE 328406-09 **EXTERIOR** INTERIOR - IRRIGATION CONTROLLER LOCATED ON INTERIOR WALL AT ARCHITECTS DIRECTION. BUILDING WALL PROVIDE 120V PLUG IN OR DIRECT POWER ACCESS. — PROVIDE ISOLATION VALVE — 3" MAINLINE REFER CONTROLLER ALSO NEEDS AN ETHERNET TO PLUMBING FOR CABLE OR ACCESS WIRELESS TO A WIRELESS LOCATION NETWORK REMOTE CONTROL VALVES - HUNTER FLOW-CLIKFLOW - IRRIGATION DEDUCT SENSOR METER (POINT OF CONNECTION) MASTER VALVE REFER TO CIVIL 3" SUPPLY LINE REFER — - BOOSTER PUMP (PER MATHER & SONS) TO PLUMBING PROVIDE 480V - 3PH POWER PVC SLEEVE MINIMUM 4" DIAMETER GENERAL NOTE: SCHEDULE A. MINIMUM CLEARANCES BETWEEN ALL COMPONENTS SHOWN ABOVE SHALL BE GOVERNED BY STATE AND LOCAL CODES OR MANUFACTURERS RECOMMENDATIONS, WHICHEVER IS GREATER. B. FIELD LOCATE AND ADJUST TO FIT

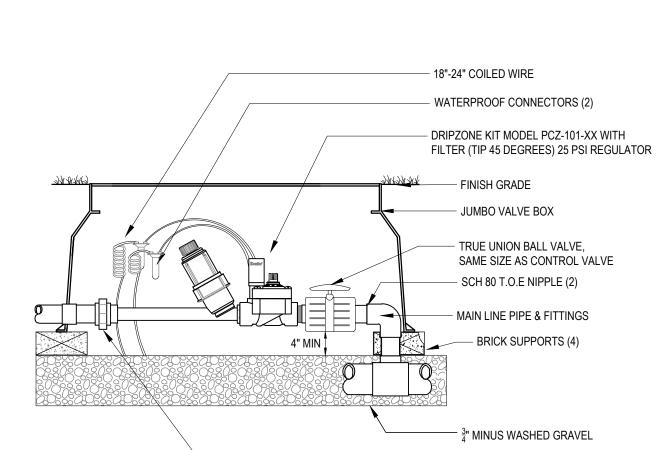

- PVS UNION, TYP.

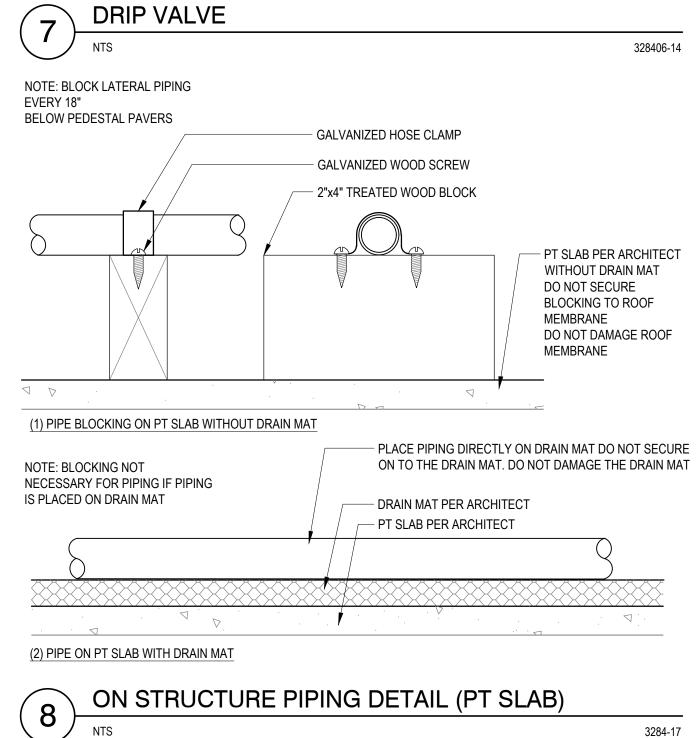

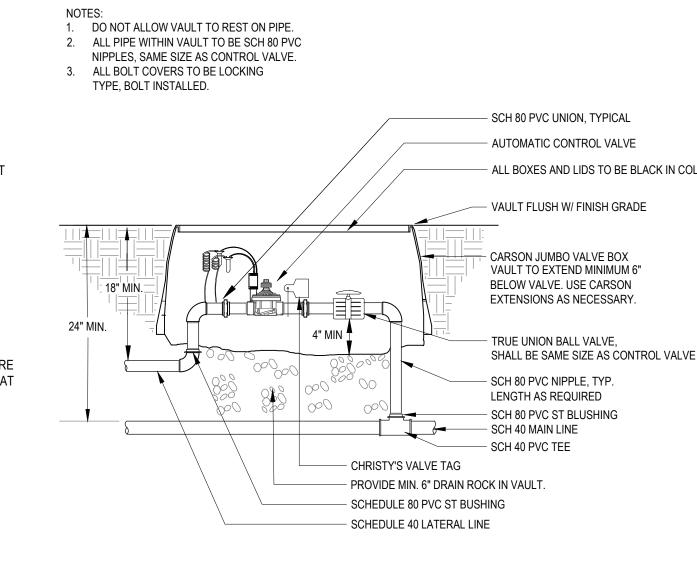


328406-08

LRS Architects, Inc. © 2020


- 1/2" INLINE DRIP **TUBING PLACED AT 6" BELOW SOIL** LIGHT WEIGHT PLANTER SOIL - ENKADRAIN 3811R DRAIN MAT - PEDESTAL PAVERS - ROOF DECK SEE ARCHITECT - 1/2" DRIP SUPPLY LINE, ALLOW 24" ADDED LENGTH UNDER PLANTER — PVC LATERAL LINE


BACKFLOW PREVENTOR AND MASTER VALVE ASSEMBLY



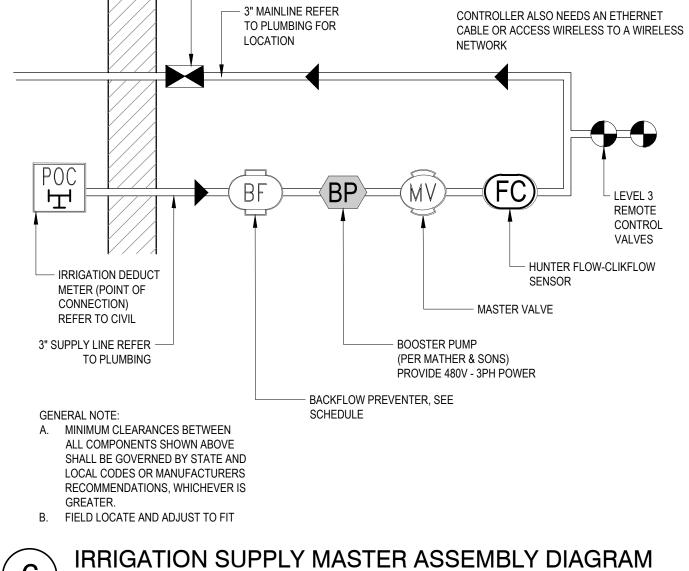



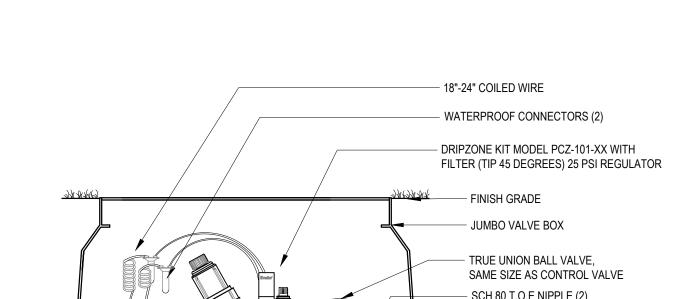


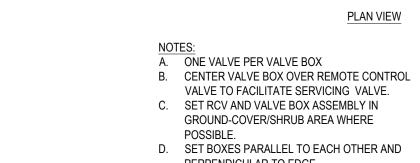


ALIGN

PERPENDICULAR

& PARALLEL TO PAVING

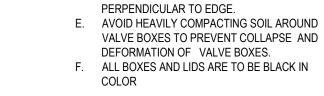


VALVE BOX LOCATION

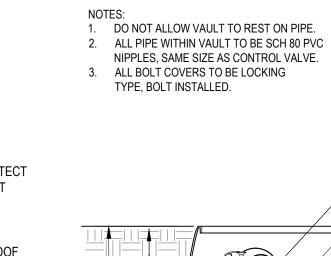


DESIGN REVIEW SUBMITTAL

ENLARGED SITE PLANS

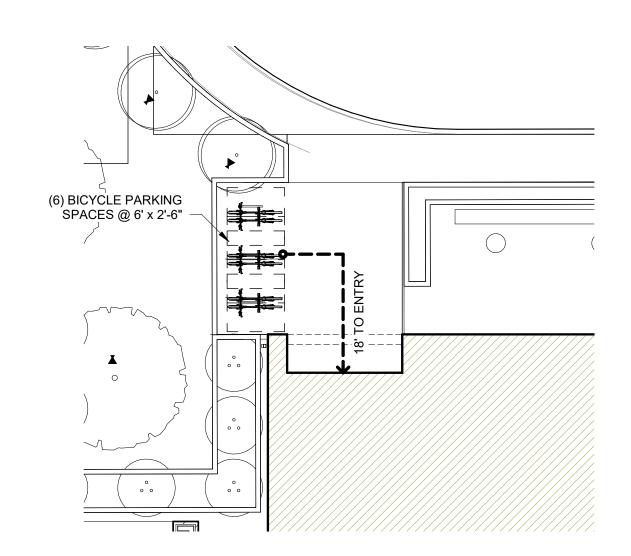



1. ENLARGED SITE PLAN AT NORTH ENTRY

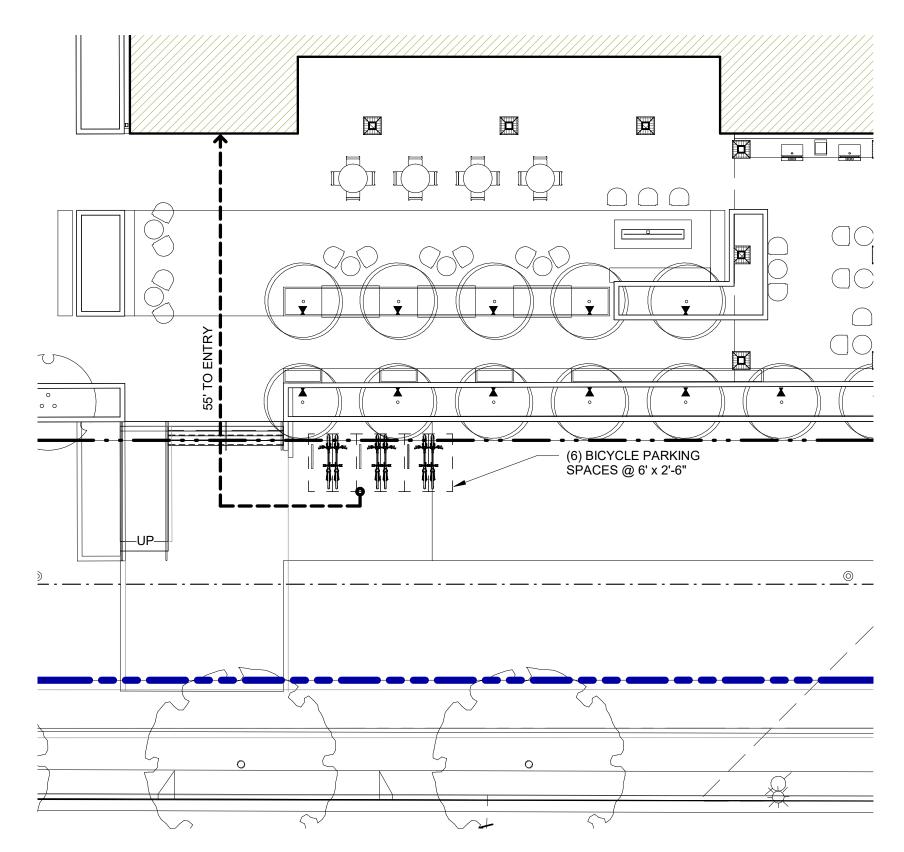


2. ENLARGED SITE PLAN AT SOUTH ENTRY



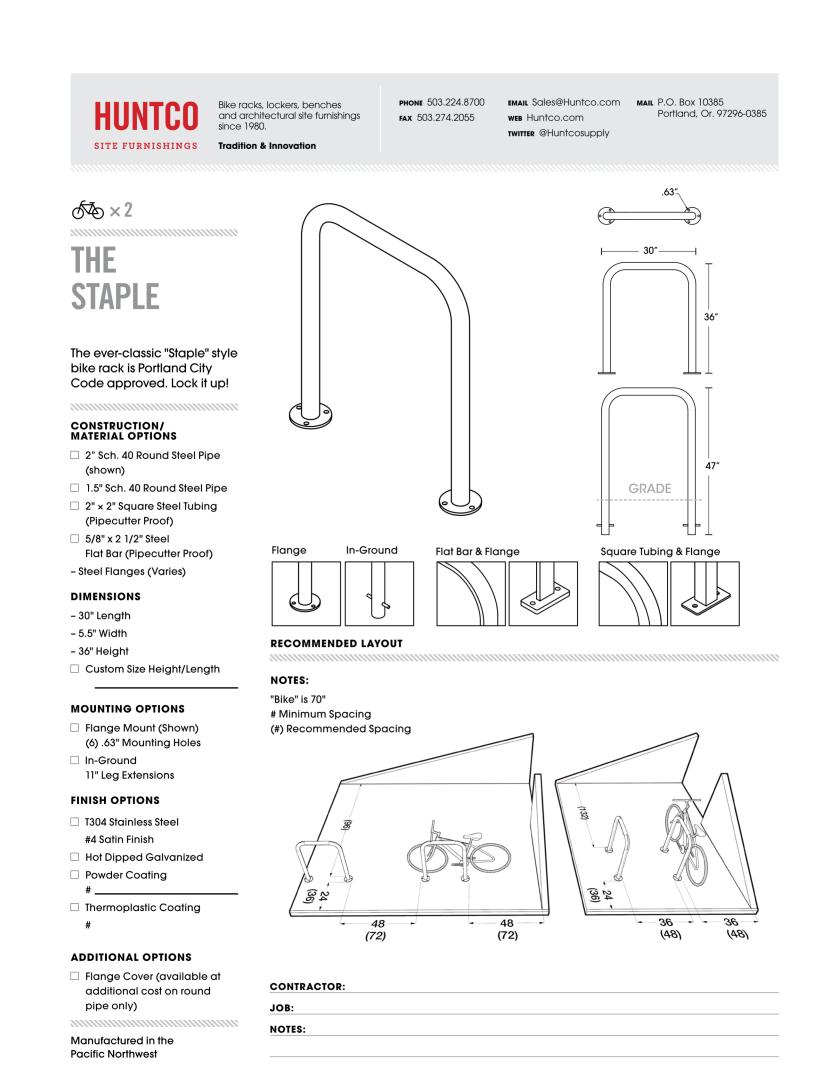

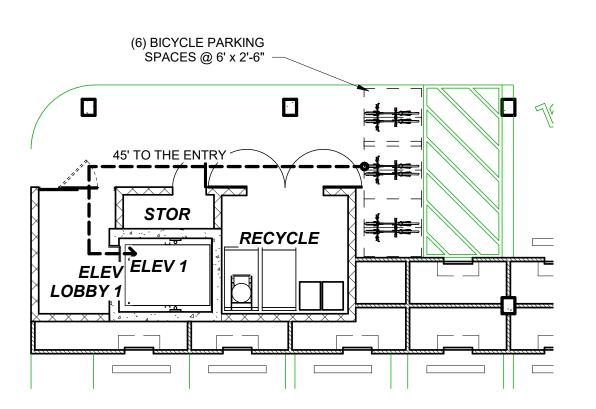

3. ENLARGED BASEMENT FLOOR PLAN

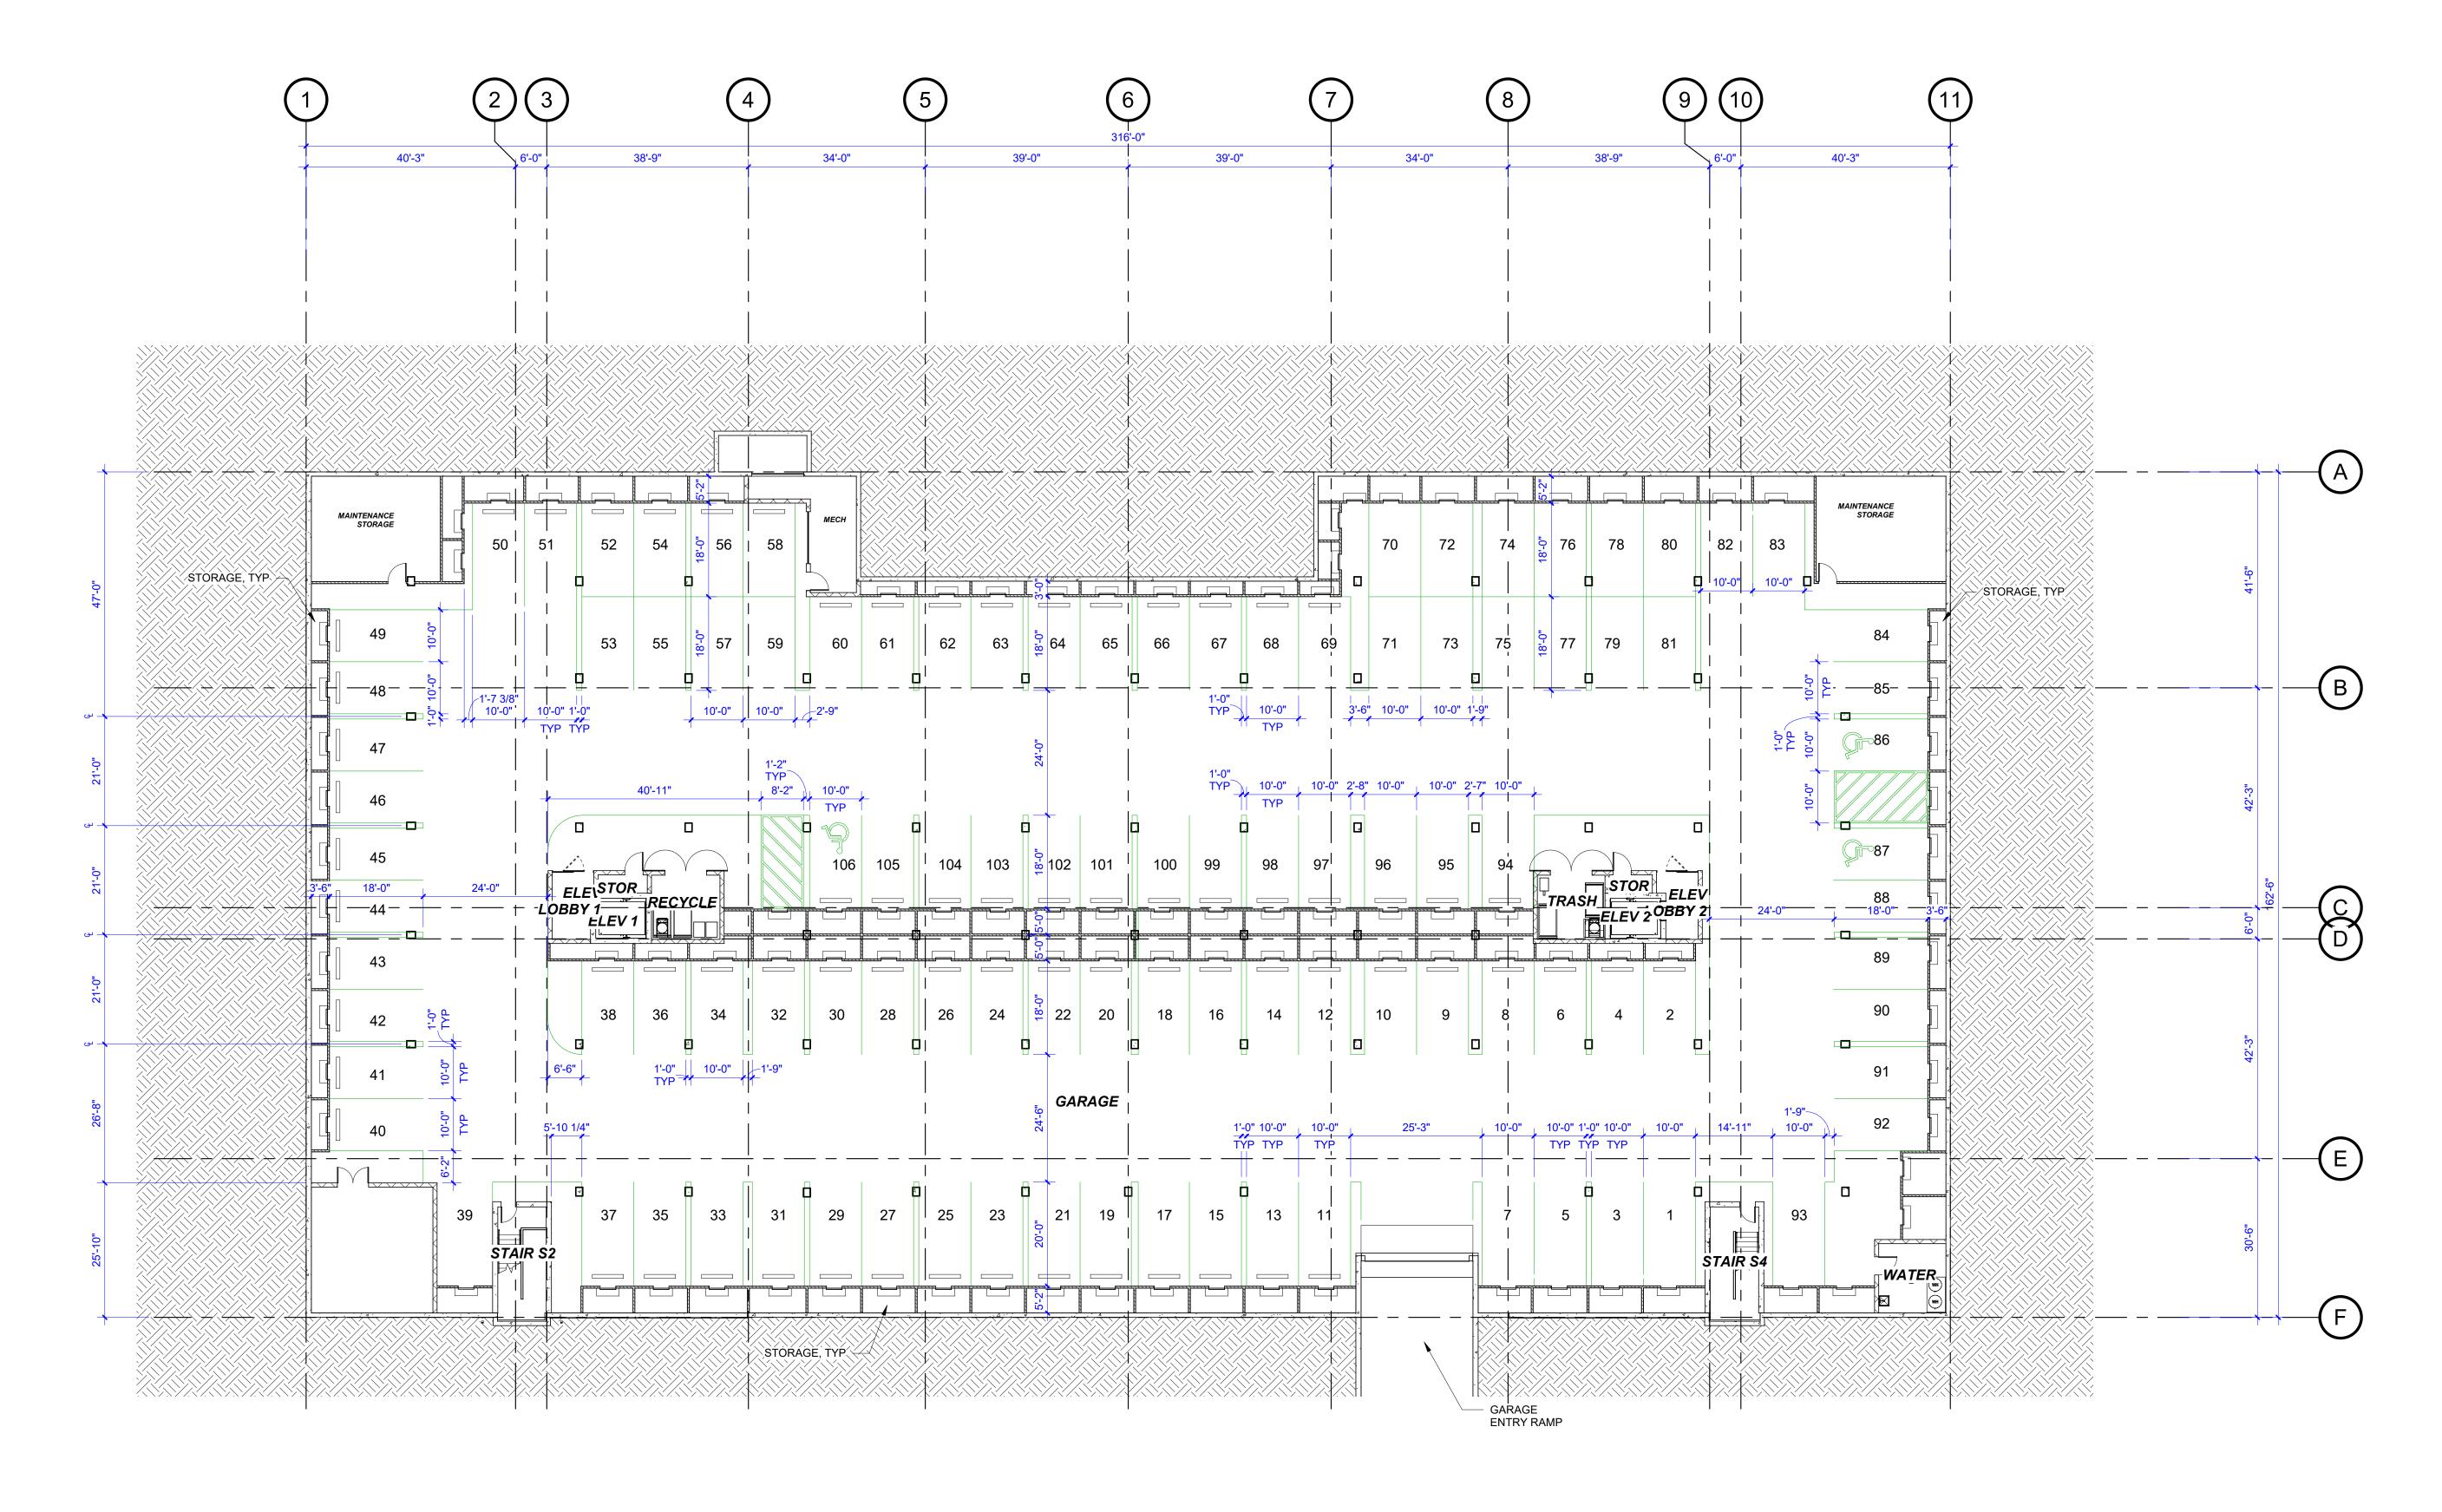




BASEMENT OVERALL FLOOR PLAN


SCALE: 1/16" = 1'-0"



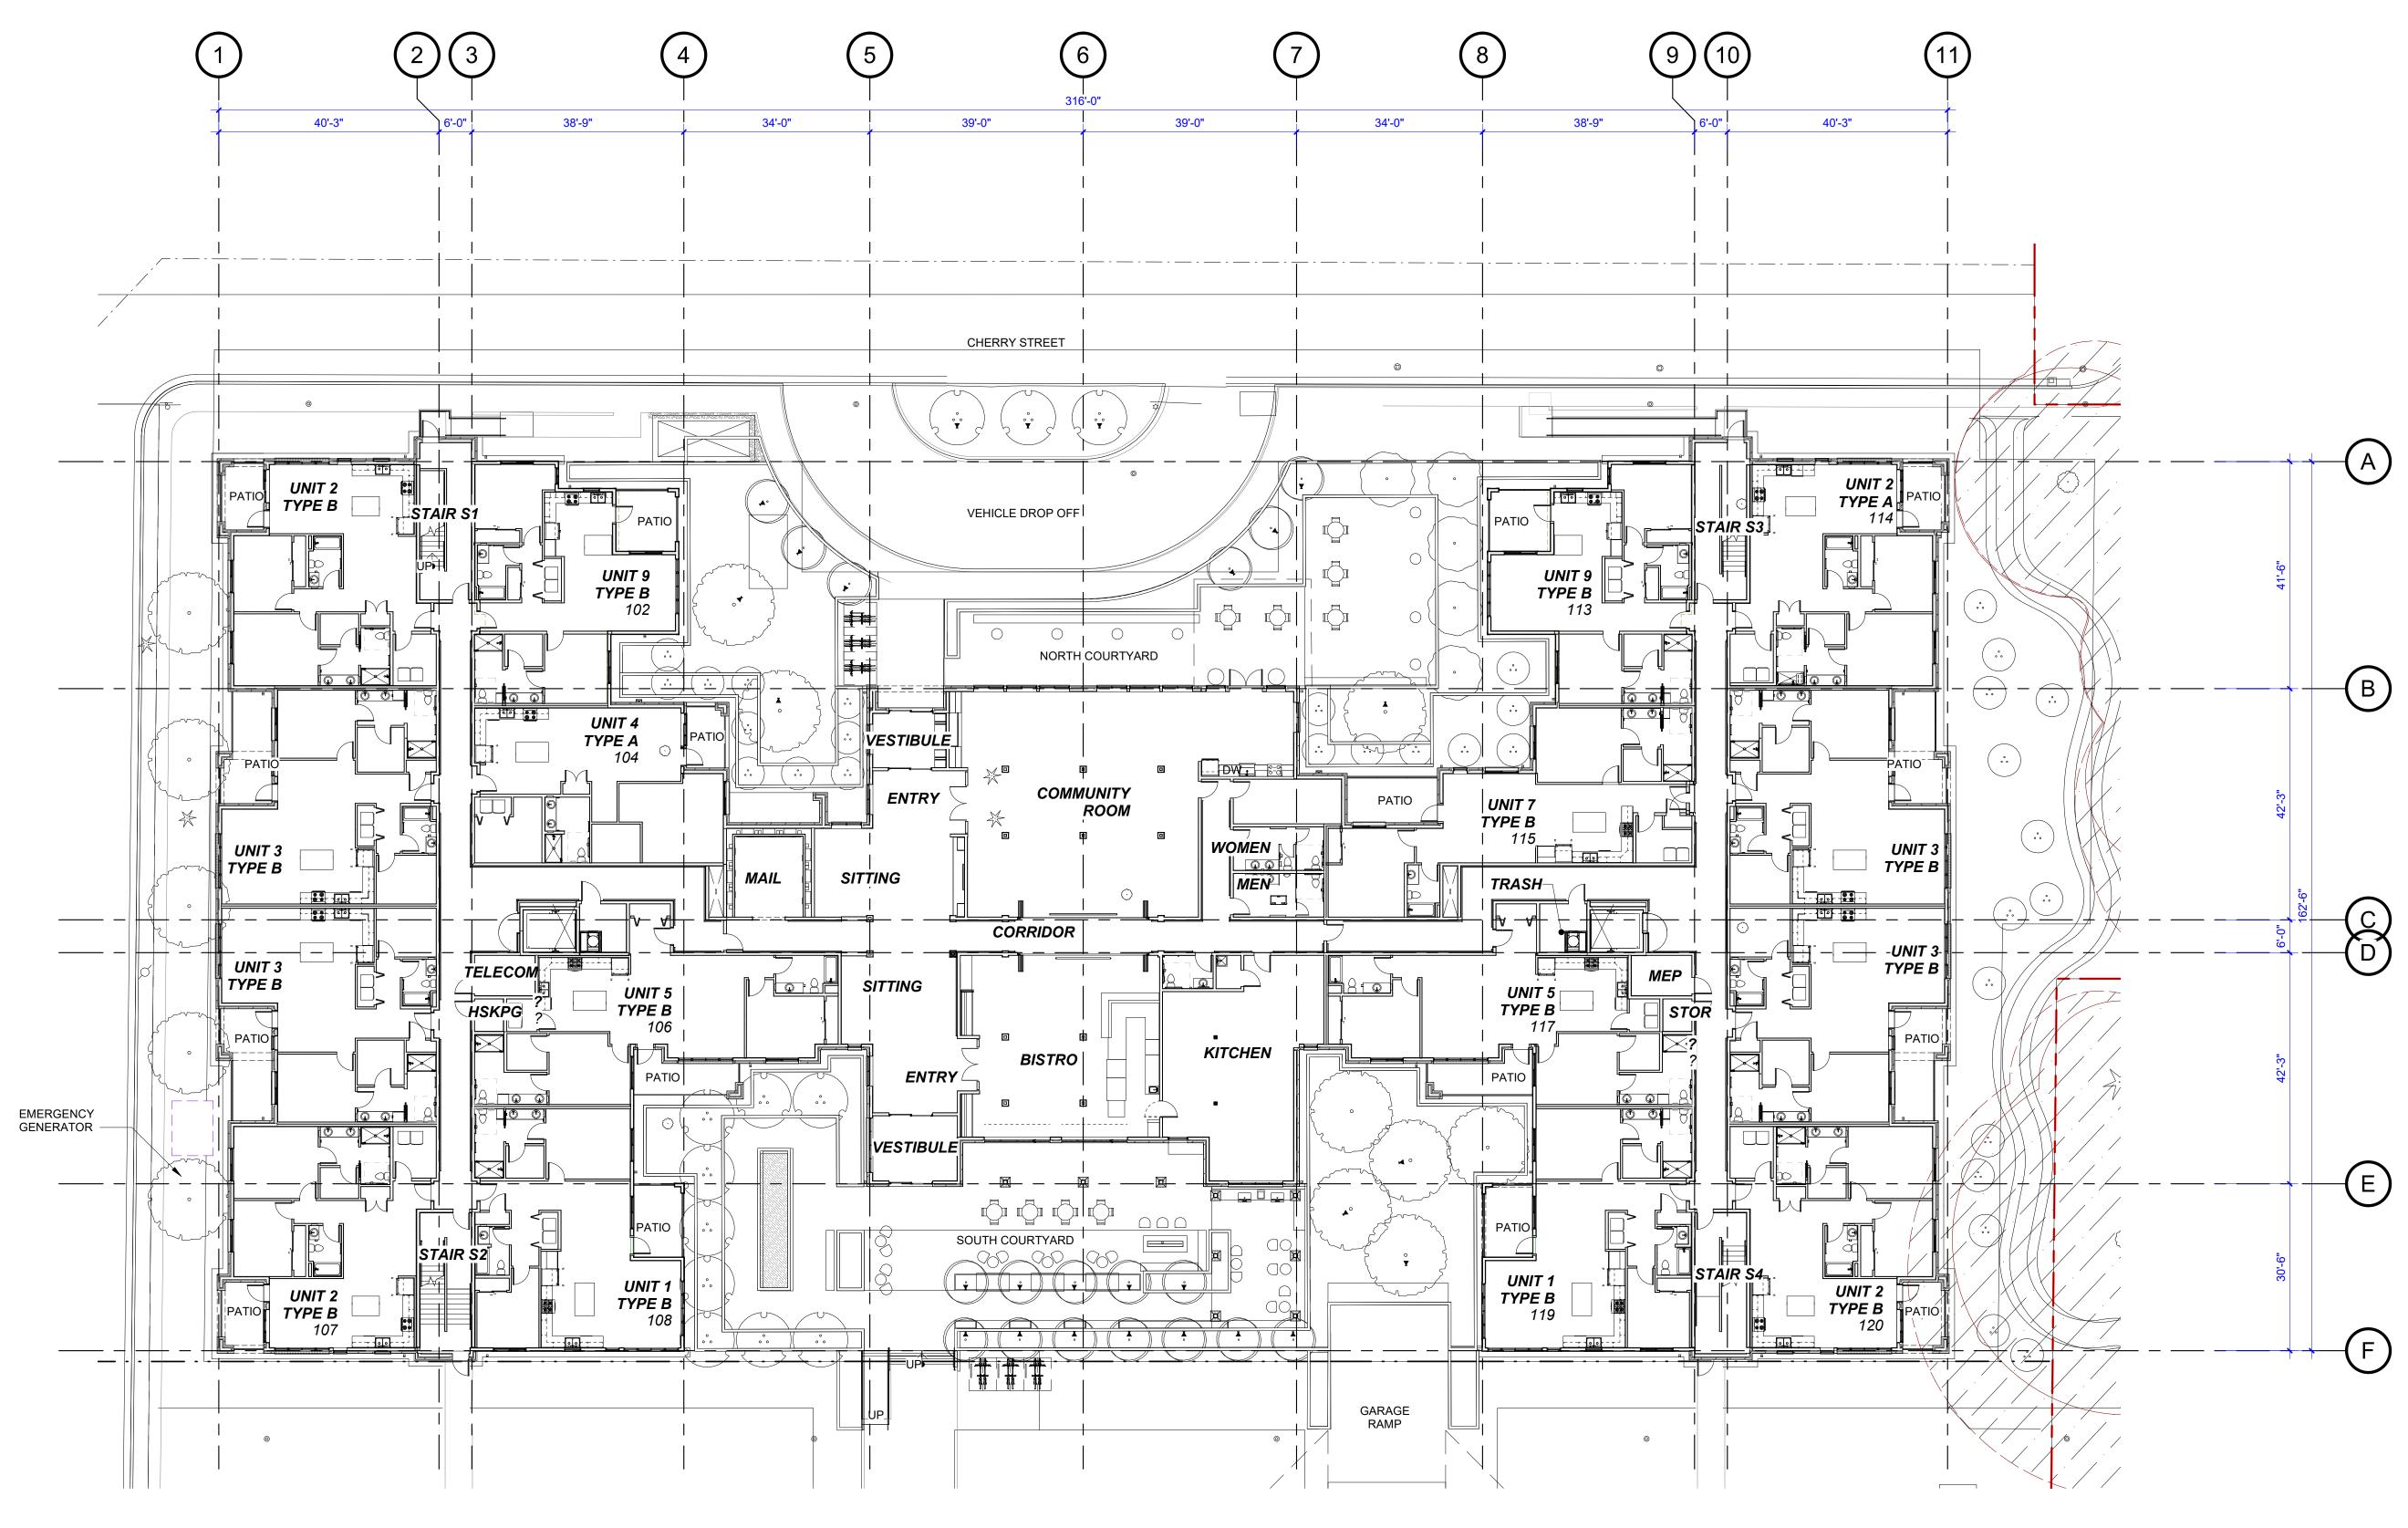


SCALE: 1/16" = 1'-0"


LEVEL 1 FLOOR PLAN

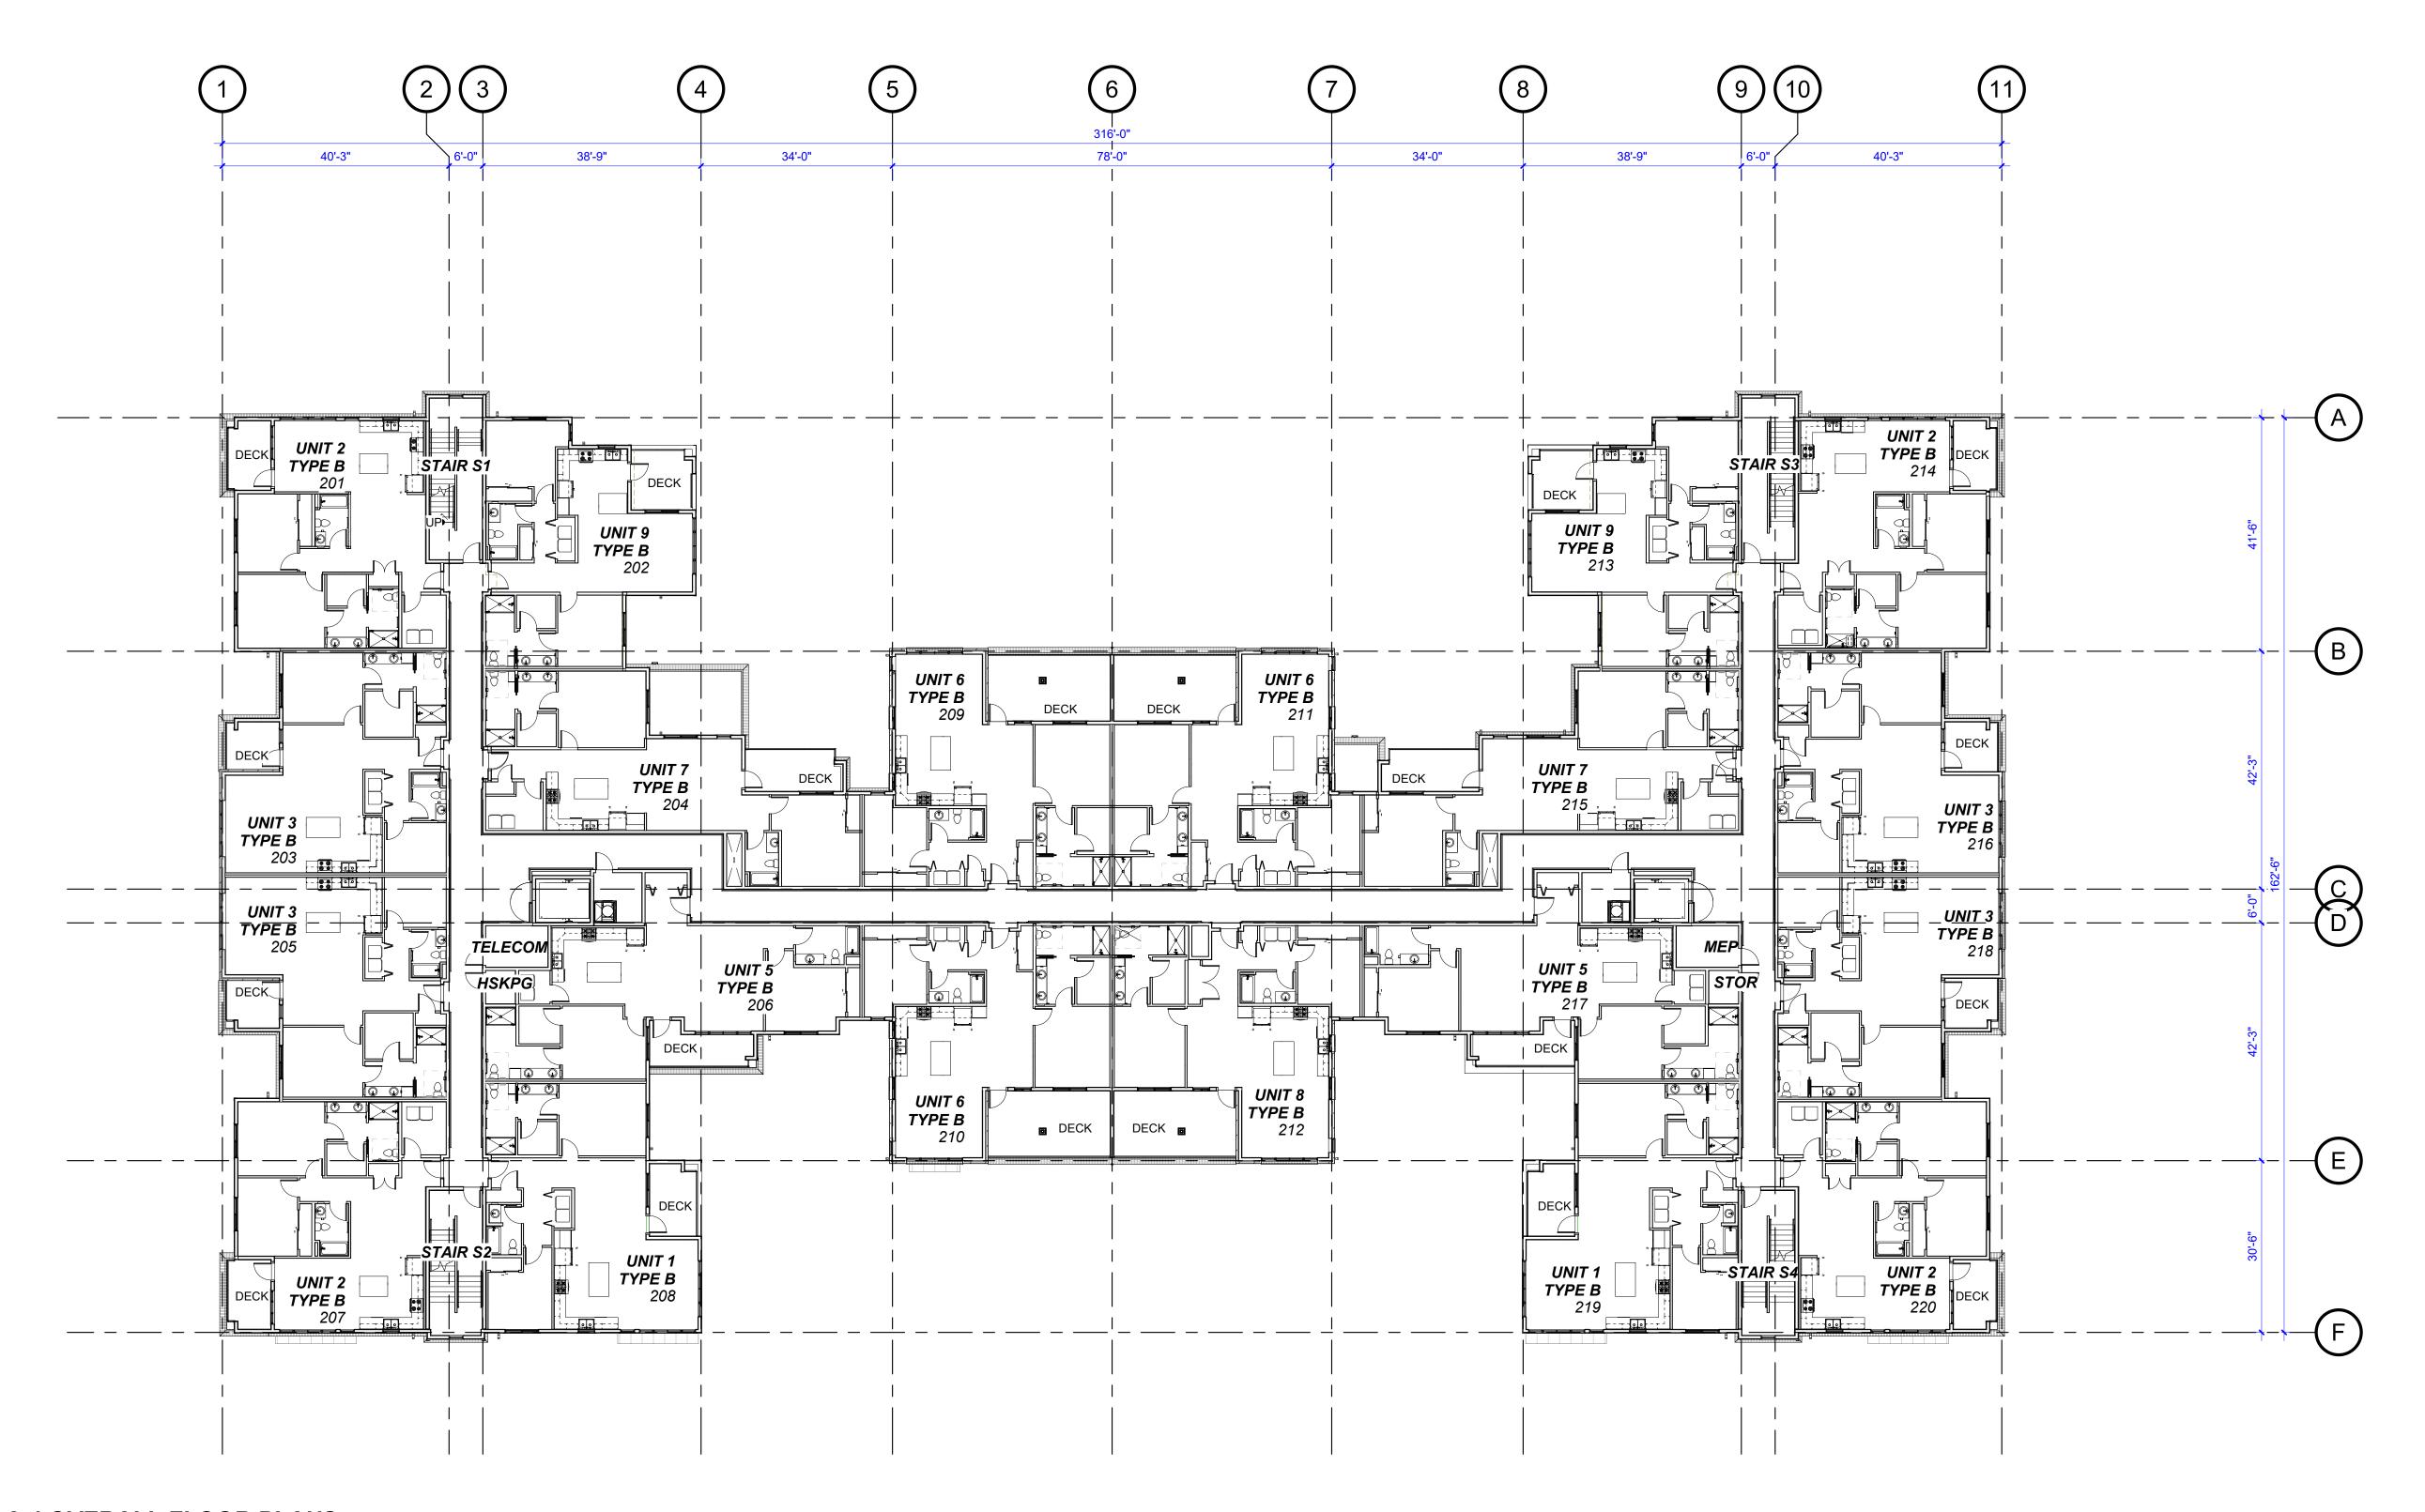


LEVELS 2-4 OVERALL FLOOR PLANS

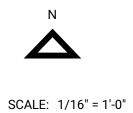

217304 | University Village Phase II (Building #1)
ARCHITECTS 7/30/20

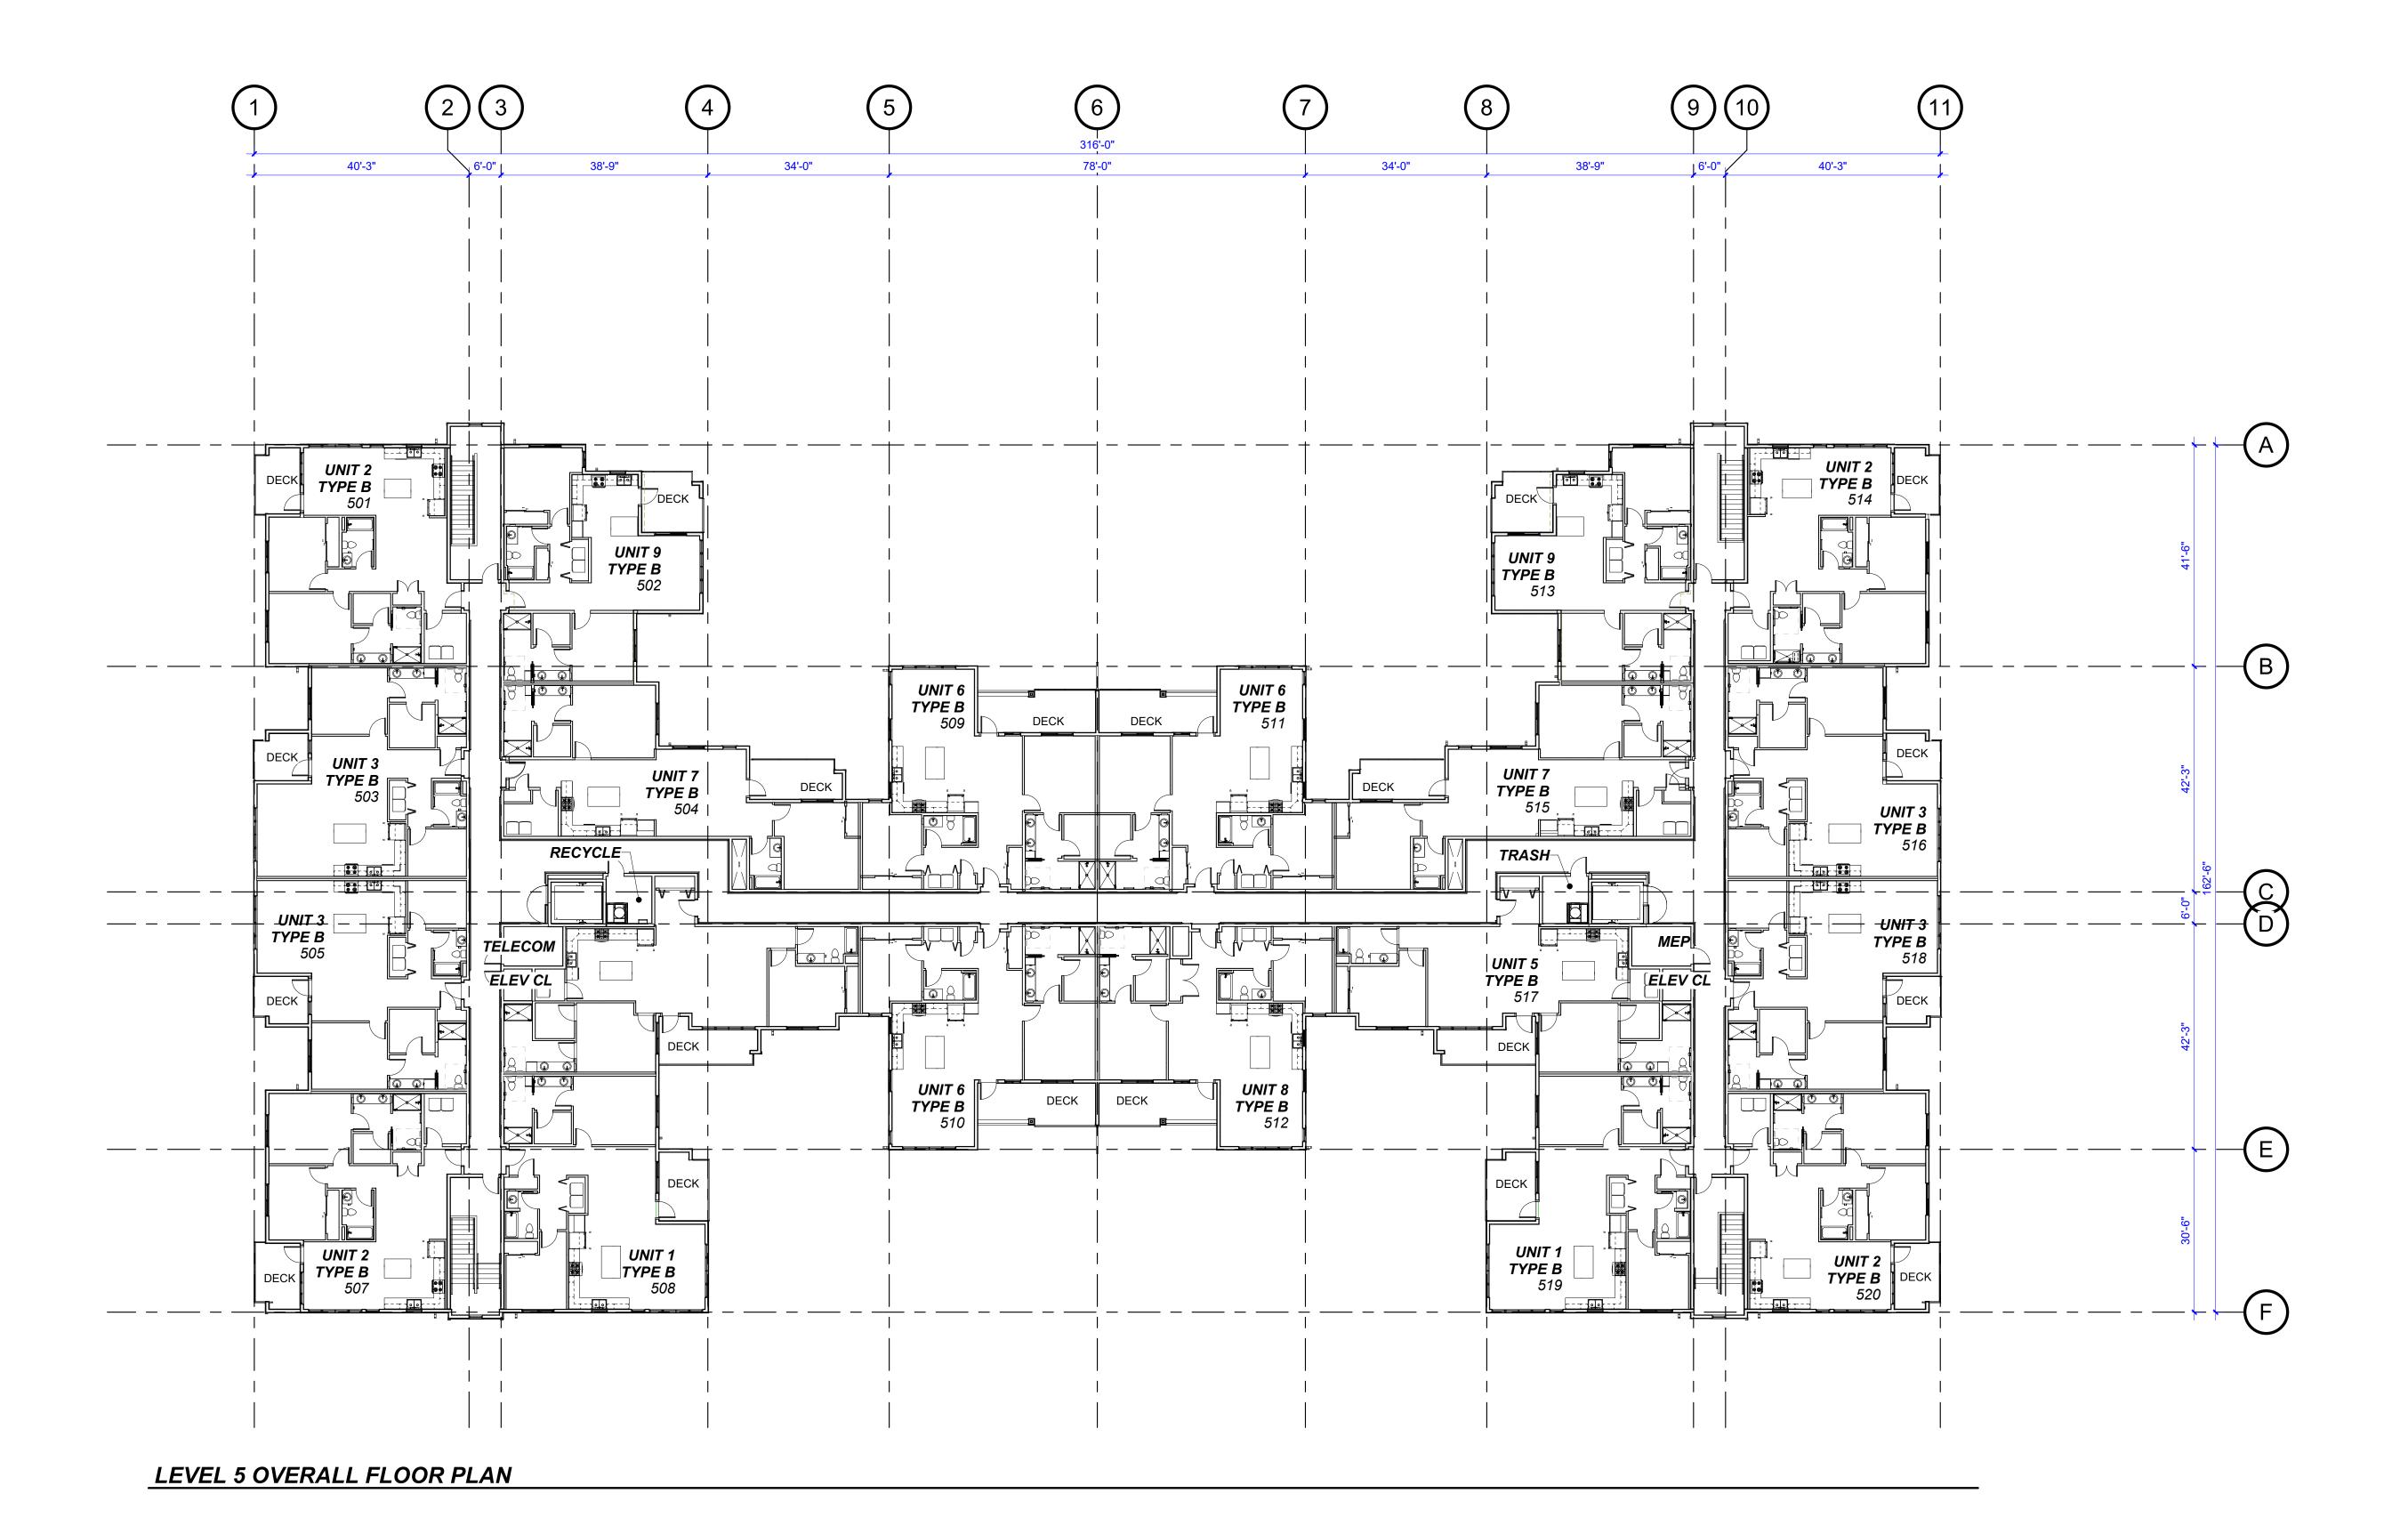

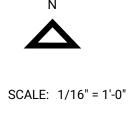

217304 | University Village Phase II (Building #1)
ARCHITECTS 7/30/20

COLORED EXTERIOR ELEVATIONS



1. PARTIAL SOUTH ELEVATION 1

SCALE: 3/32" = 1'-0"



2. PARTIAL SOUTH ELEVATION 2

SCALE: 3/32" = 1'-0"



1. PARTIAL NORTH ELEVATION 1

SCALE: 3/32" = 1'-0"



2. PARTIAL NORTH ELEVATION 2

SCALE: 3/32" = 1'-0"



SCALE: 3/32" = 1'-0"



3. OVERALL EAST ELEVATION

SCALE: 3/32" = 1'-0"

KEYNOTES

199'-3"Œ

DOWNSPOUT

BRICK FINISH PER WALL TYPE SCHEDULE VINYL WINDOW, SEE WINDOW TYPES, TYP

DESIGN REVIEW SUBMITTAL

COLORED EXTERIOR ELEVATIONS

KEYNOTES

VINYL WINDOW, SEE WINDOW TYPES, TYP

CEMENTITIOUS TRIM, RUSTIC

DOWNSPOUT



1. SECTOR A - EAST ELEVATION

SCALE: 3/32" = 1'-0"



SCALE: 3/32" = 1'-0"

SCALE: 3/32" = 1'-0"




SCALE: 3/32" = 1'-0"



4. SECTOR C - WEST ELEVATION

SCALE: 3/32" = 1'-0"

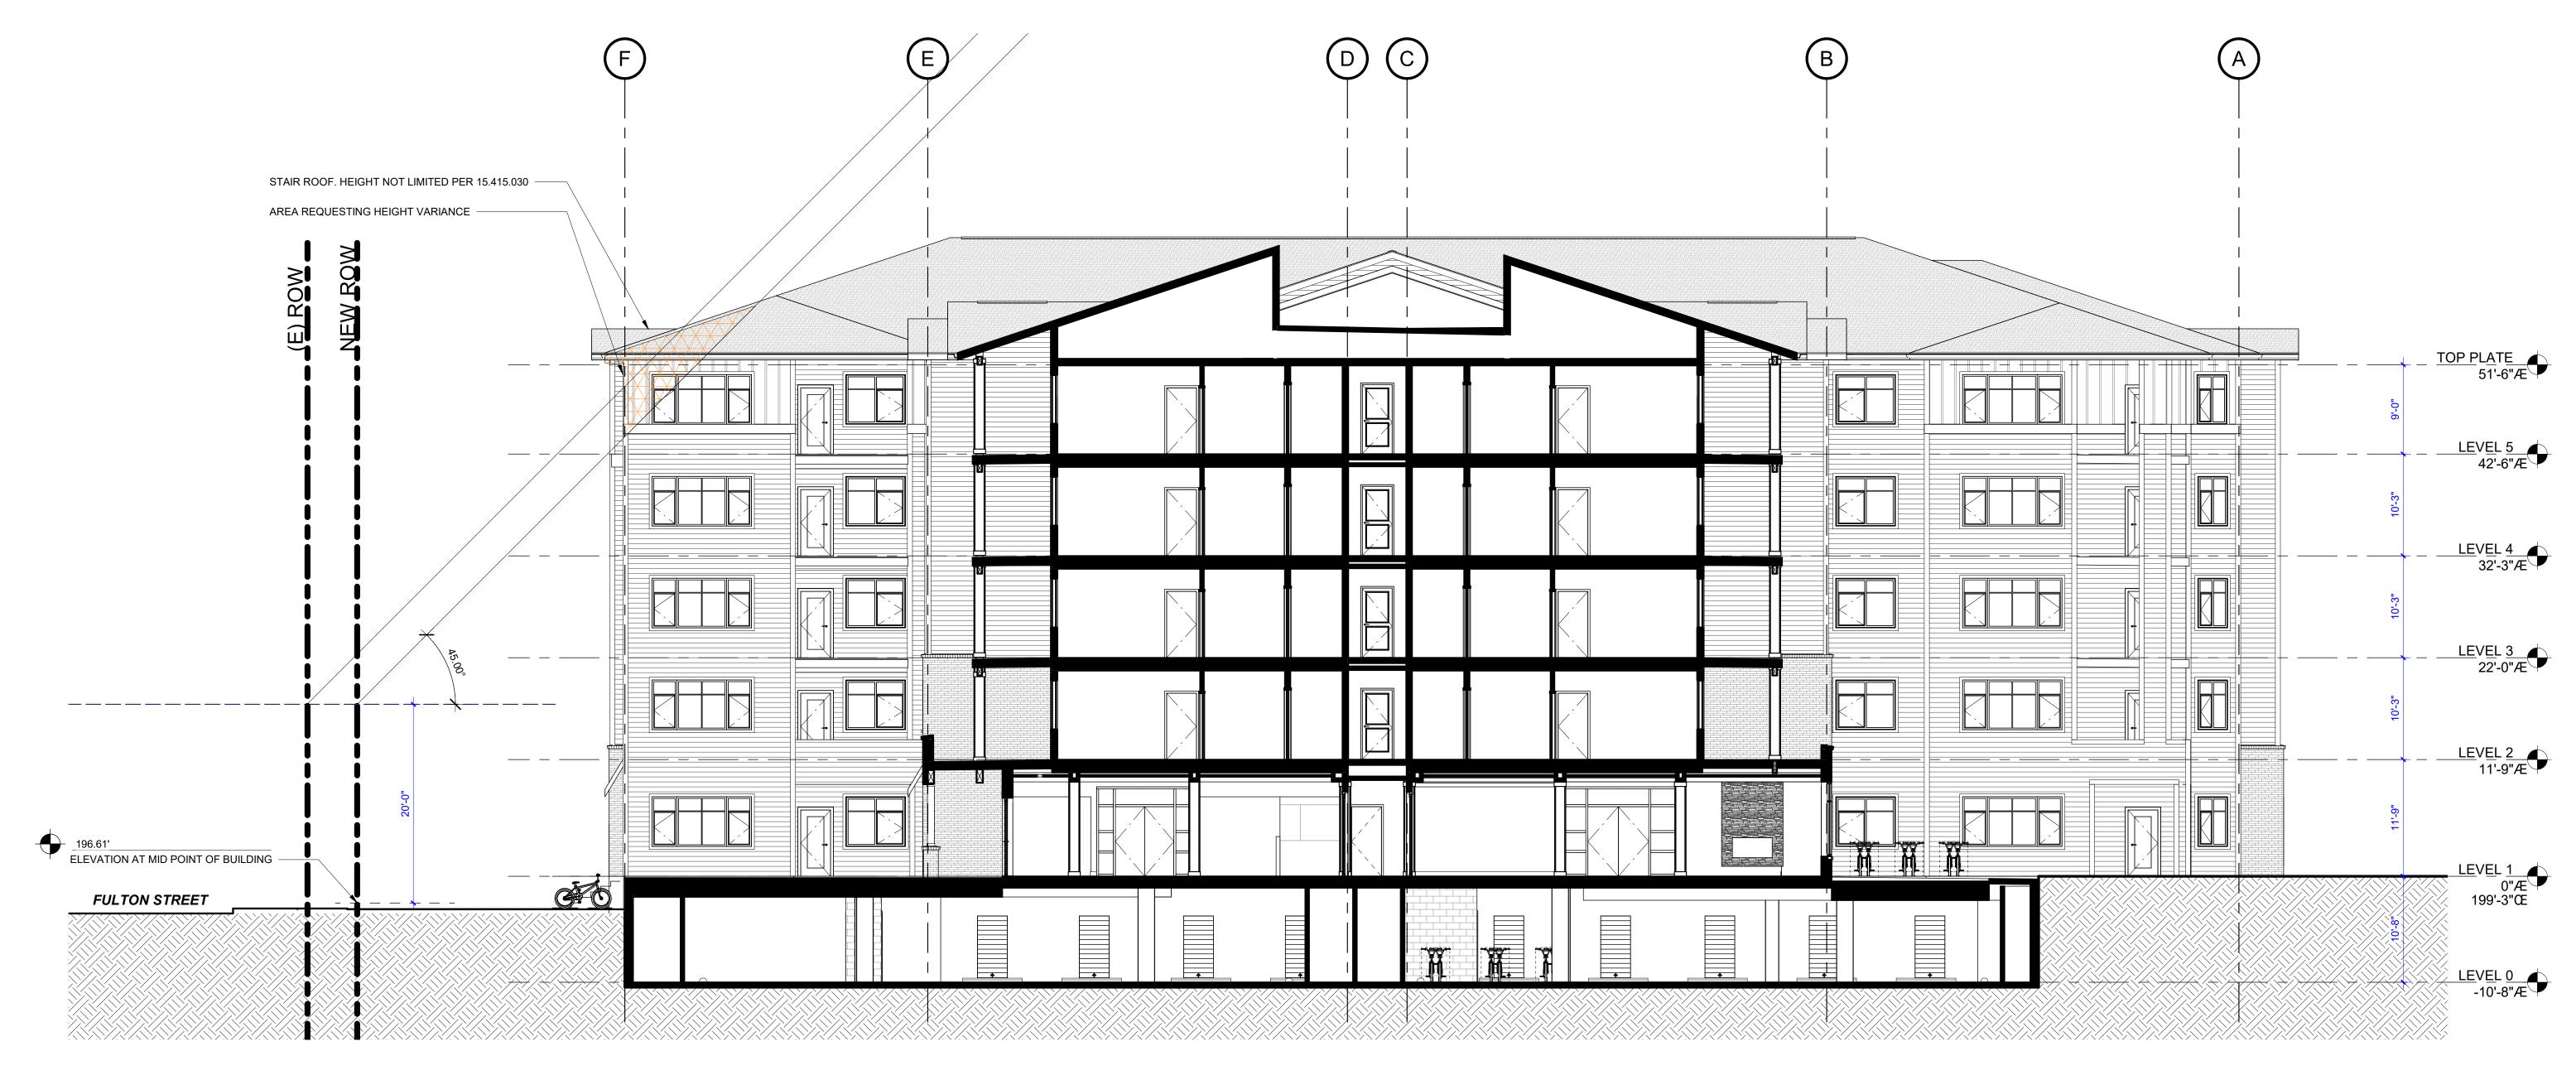


15.415.020 Building height limitation

E. Alternative <u>Building Height</u> Standard. As an alternative to the <u>building height</u> standards above, any project may elect to <u>use</u> the following standard (see Figure 24 in Appendix A). To meet this standard:

1. Each point on the <u>building</u> must be no more than 20 feet higher than the ground level at all points on the property lines, plus one vertical foot for each horizontal foot of distance from that property line; and

2. Each point on the <u>building</u> must be no more than 20 feet higher than the ground level at a point directly north on a property line, plus one vertical foot for each two horizontal feet of distance between those points. This second limit does not apply if the property directly to the north is a <u>right-of-way</u>, parking <u>lot</u>, protected natural resource, or similar unbuildable property.

F. <u>Buildings</u> within the <u>airport</u> overlay subdistrict are subject to the height limits of that subdistrict. [Ord. <u>2730</u> § 1 (Exh. A (4)), 10-18-10; Ord. <u>2720</u> § 1(10), 11-2-09; Ord. <u>2647</u>, 6-5-06; Ord. <u>2564</u>, 4-15-02; Ord. <u>2550</u>, 5-21-01; Ord. <u>2451</u>, 12-2-96. Code 2001 § 151.536.]

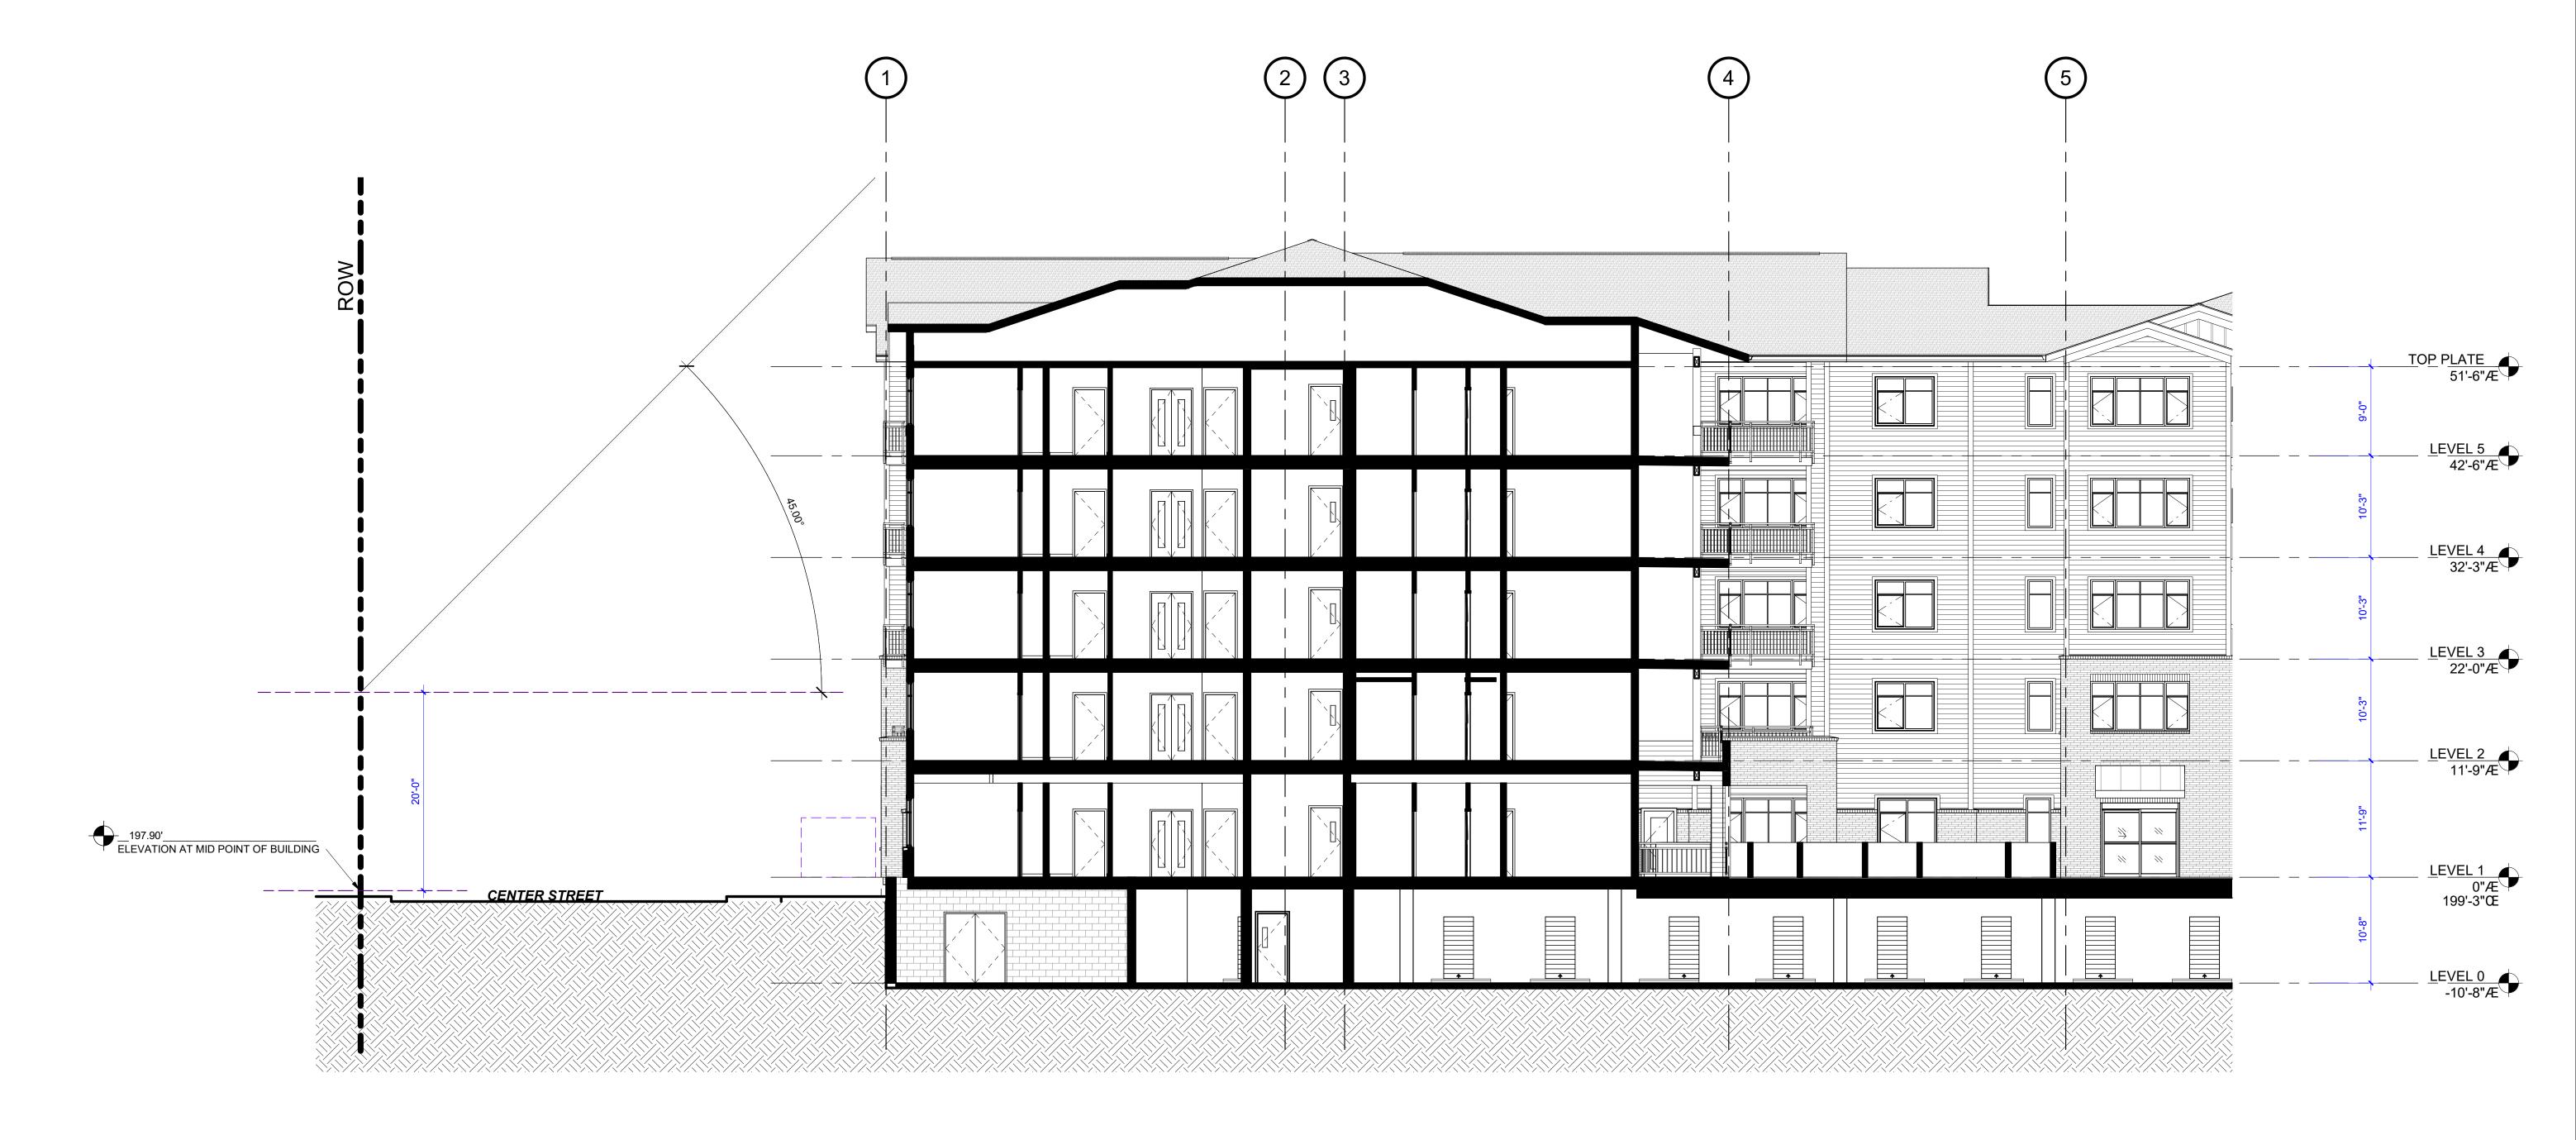

1. ALTERNATE BUILDING HEIGHT SECTION AT CENTER

SCALE: 1/8" = 1'-0"

15.415.020 Building height limitation

- E. Alternative <u>Building Height</u> Standard. As an alternative to the <u>building height</u> standards above, any project may elect to <u>use</u> the following standard (see Figure 24 in Appendix A). To meet this standard:
- 1. Each point on the <u>building</u> must be no more than 20 feet higher than the ground level at all points on the property lines, plus one vertical foot for each horizontal foot of distance from that property line; and
- 2. Each point on the <u>building</u> must be no more than 20 feet higher than the ground level at a point directly north on a property line, plus one vertical foot for each two horizontal feet of distance between those points. This second limit does not apply if the property directly to the north is a <u>right-of-way</u>, parking <u>lot</u>, protected natural resource, or similar unbuildable property.
- F. <u>Buildings</u> within the <u>airport</u> overlay subdistrict are subject to the height limits of that subdistrict. [Ord. <u>2730</u> § 1 (Exh. A (4)), 10-18-10; Ord. <u>2720</u> § 1(10), 11-2-09; Ord. <u>2647</u>, 6-5-06; Ord. <u>2564</u>, 4-15-02; Ord. <u>2550</u>, 5-21-01; Ord. <u>2451</u>, 12-2-96. Code 2001 § 151.536.]

SCALE: 1/8" = 1'-0"




DESIGN REVIEW SUBMITTAL


USABLE OUTDOOR AREA

SCALE: 1" = 40'-0"


217304 | University Village Phase II (Building #1)

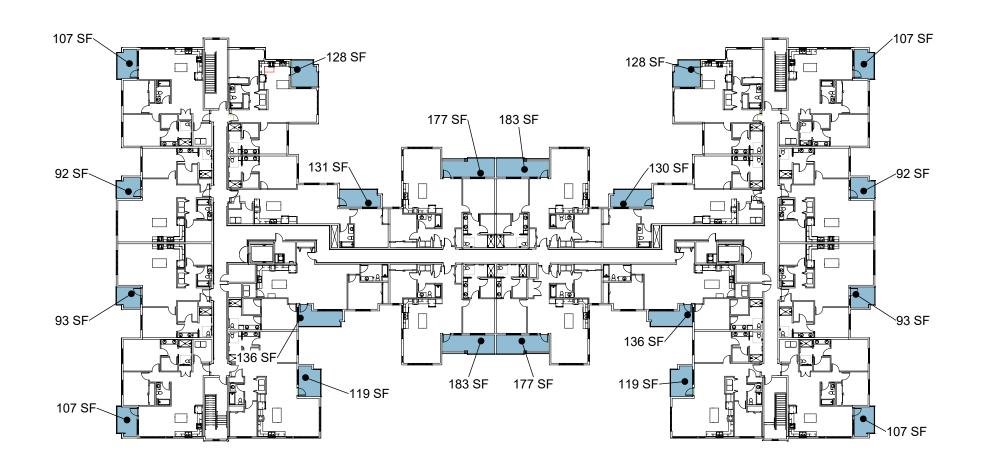

5. LEVEL 5 USABLE OUTDOOR AREA

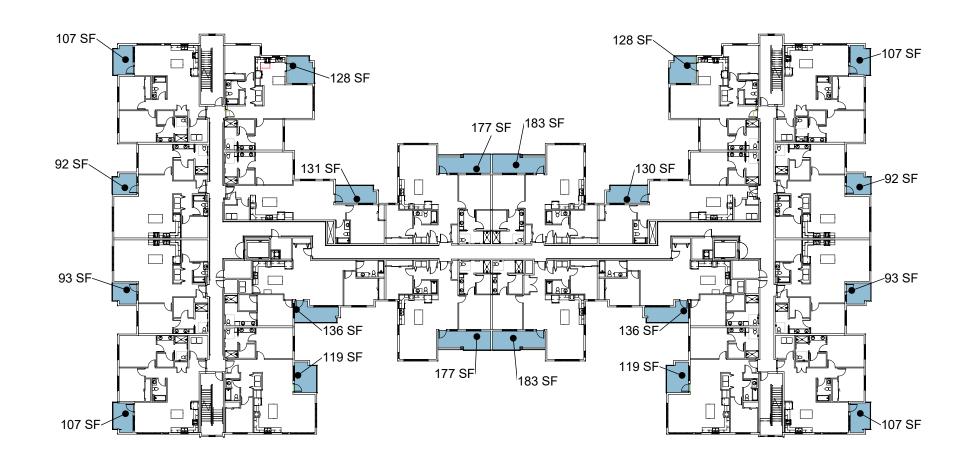

4. LEVEL 4 USABLE OUTDOOR AREA

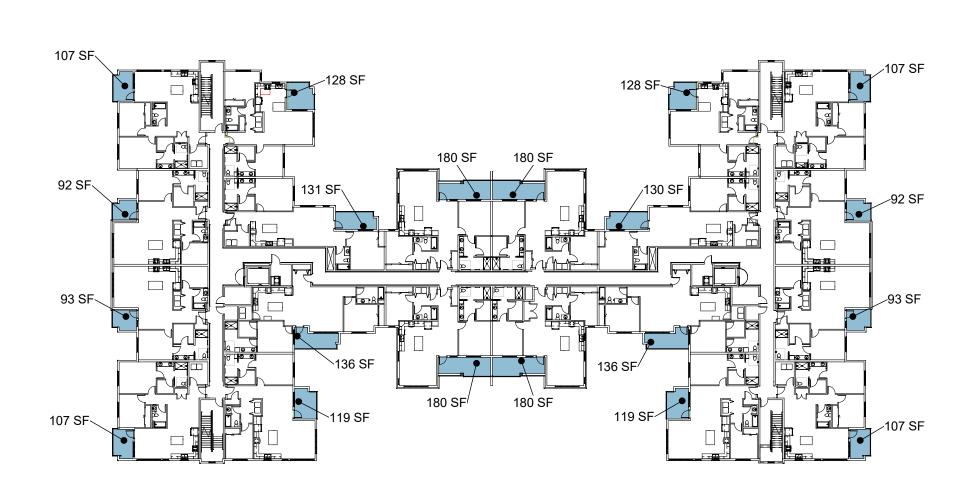

3. LEVEL 3 USABLE OUTDOOR AREA

Area Schedule (Usable Private Outdoor Area) 15.420.010.A USABLE PRIVATE OUTDOOR AREAS

15.420.010.A USABLE PRIVATE OUTDOOR AREAS
48 SF / UNIT x 16 UNITS = 788 SF REQUIRED.


2,236 SF PRIVATE OUTDOOR AREA PROVIDED
(AREA INCLUDES GROUND FLOOR PATIOS ONLY)

<u>Area Schedule</u> (Usable Public Outdoor area)


15.420.010.B USABLE PUBLIC OUTDOOR AREAS 1 BED AND 2 BED - 200 SF/ UNIT 3 BED AND UP - 300 SF/ UNIT

96 1-BED AND 2-BED UNITS X 200 SF = 19,200 SF USABLE OUTDOOR AREA REQUIRED


21,509 SF PUBLIC OUTDOOR AREA PROVIDED

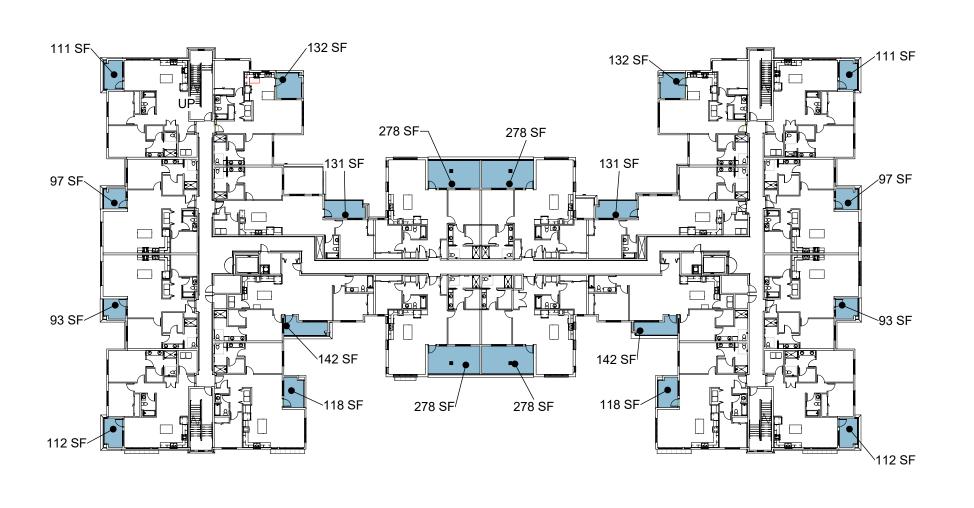

2. LEVEL 2 USABLE OUTDOOR AREA

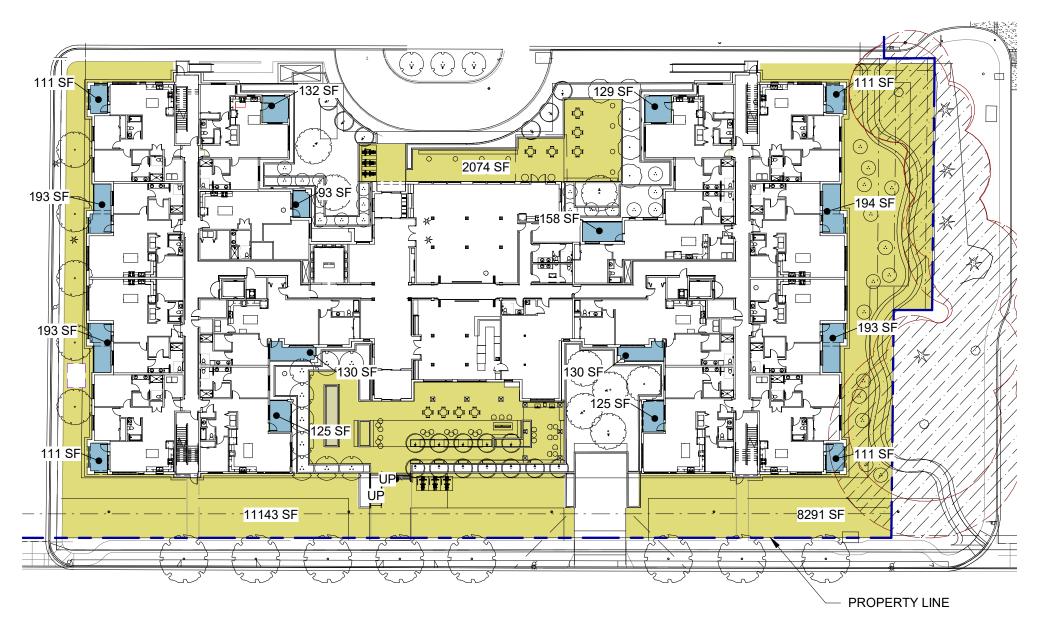

1. LEVEL 1 USABLE OUTDOOR AREA

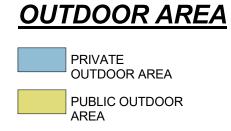





 COMPOSITION SHINGLE ROOFING SYSTEM MANUFACTURER: CERTAINTEED COLOR: BLACK WALNUT



3. FIBER CEMENT SIDING SYSTEM STYLE: 7-1/4" LAP SIDING TEXTURE: RUSTIC / SELECT CEDAR MILL COLOR: BENJAMIN MOORE PAINT: HC-83, GRANT BEIGE




 FIBER CEMENT SIDING SYSTEM STYLE: 7-1/4" LAP SIDING TEXTURE: RUSTIC / SELECT CEDAR MILL COLOR: BENJAMIN MOORE PAINT: HC-89, NORTHAMPTON PUTTY



7. FIBER CEMENT SIDING SYSTEM
STYLE: 7-1/4" LAP SIDING
TEXTURE: RUSTIC / SELECT CEDAR MILL
COLOR: BENJAMIN MOORE PAINT: HC-100, GLOUCESTER SAGE




2. ALUMINUM RAILING SYSTEM FINISH: PRE- FINISHED, BLACK ANODIZED

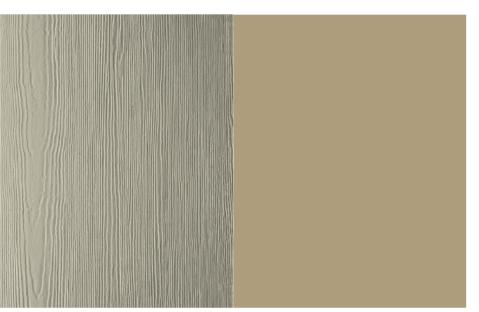

4. FIBER CEMENT SIDING SYSTEM STYLE: 2" BOARD AND BATTEN TEXTURE: SMOOTH TEXTURE / SELECT CEDAR MILL COLOR: BENJAMIN MOORE PAINT: HC-89, NORTHAMPTON PUTTY



6. FIBER CEMENT TRIM
TEXTURE: SMOOTH TEXTURE
COLOR: SHERWIN WILLIAMS PAINT: 7511, GREEK VILLA

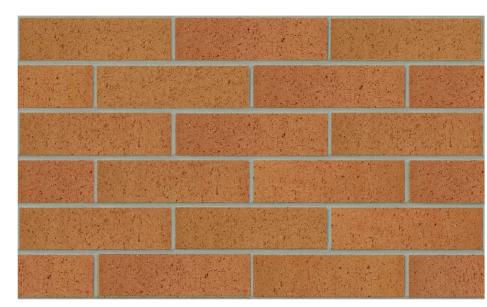


8. BRICK
STYLE: NORMAN, 3-1/2"x2-1/2"x11-1/2"
TEXTURE: PACIFIC CLAY PRODUCTS, INC., "VELOUR."
COLOR:PACIFIC CLAY PRODUCTS, INC., "ROYAL SALTILLO."




10. STANDING METAL SEAM ROOFING SYSTEM FINISH: DURATECH 5000, WEATHERED COPPER

ALUMINUM STOREFRONT SYSTEM FINISH: CLEAR ANODIZED

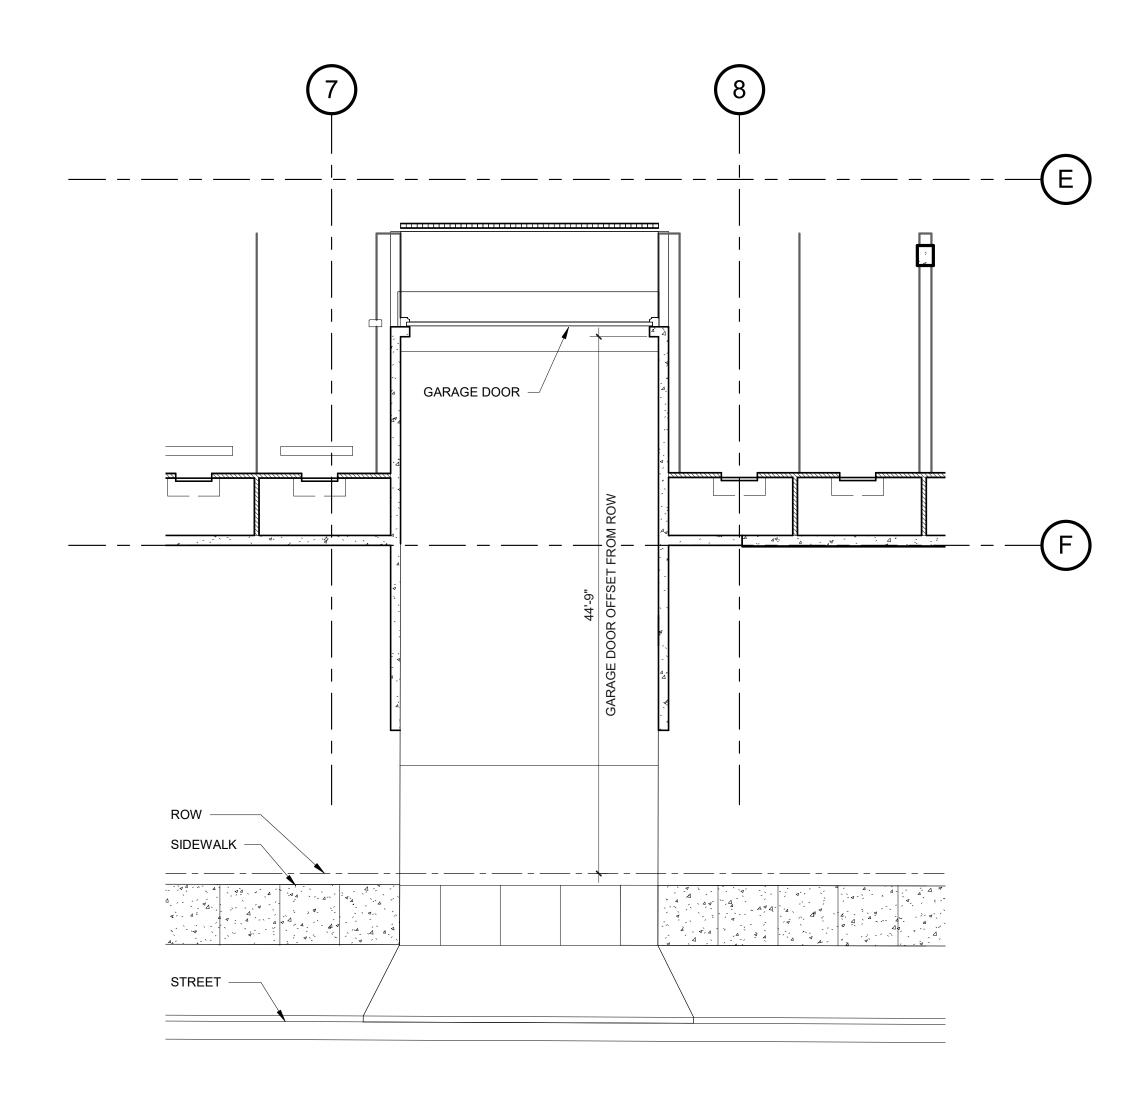

1. LUR - GARAGE ENTRY PLAN SCALE: 1/8" = 1'-0"

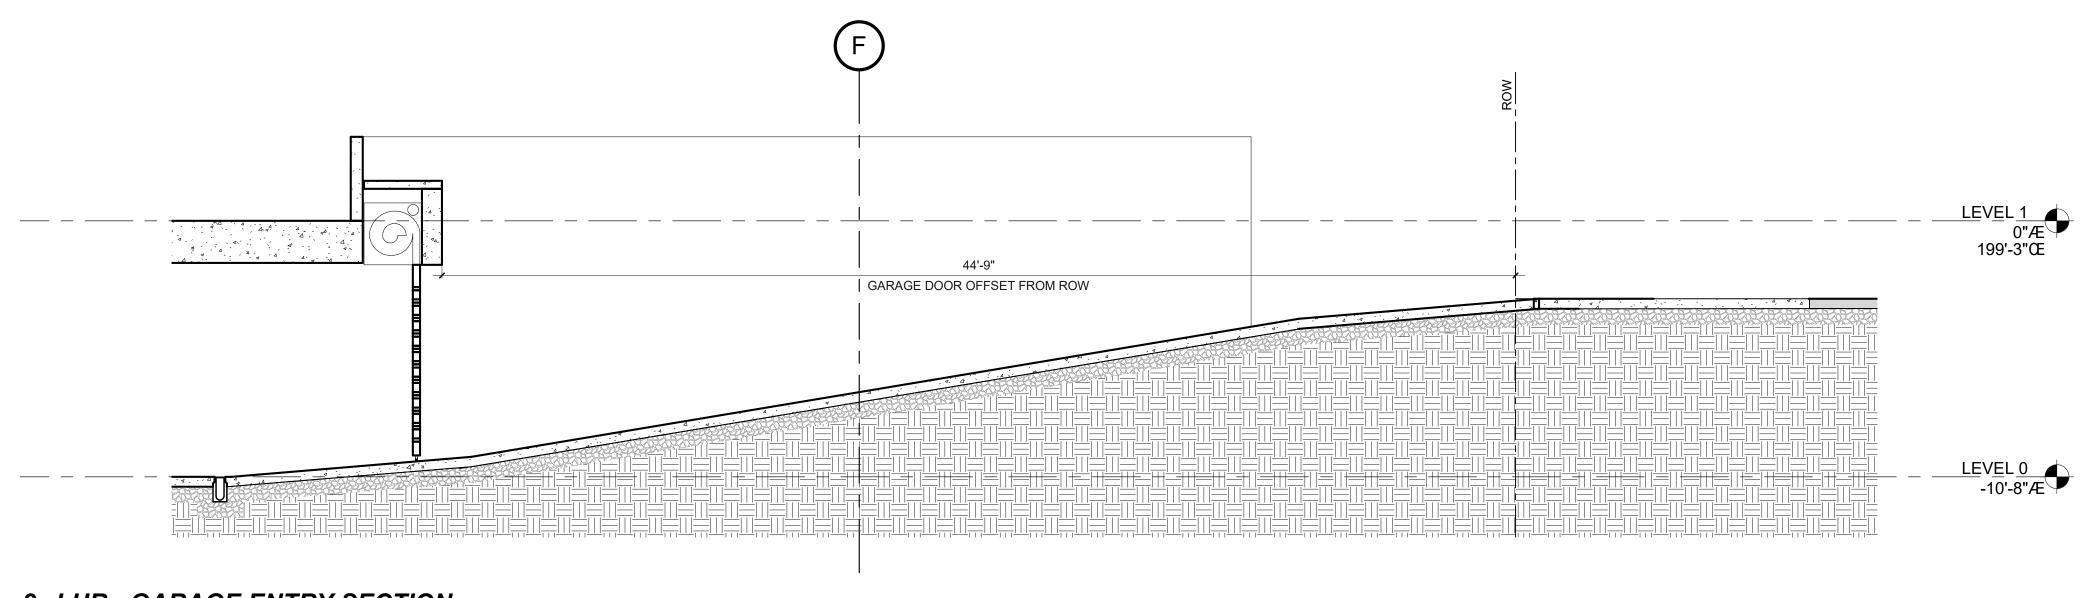

2. LUR - GARAGE ENTRY SECTION

SCALE: 1/4" = 1'-0"

ARCHITECTS

720 NW Davis 503.221.1121 **S**Suite 300 503 221.2077

Portland OR 97209 www.lrsarchitects.com

PRELIMINARY NOT FOR CONSTRUCTION

CONSULTANT:

MAZZETT

121 SW Salmon St., Suite 100

121 SW Salmon St., Suite 1000 Portland, OR 97204-2918 Tel: 503.620.3232 www.mazzetti.com

Project Number: 185–072

PROJECT NUMBER:

University Village Phase II 1001 Fulton Street, Newberg OR 97132

SHEET TITLE:

DRAWN BY: DATE ISSUED:

Author .: 05/01/20

SHEET: **E1.00LU**100% SCHEMATIC DESIGN SET

FULTON STREET

LUMINARE SCHEDULE

SOME STREET

LUMINARE SCHEDULE

SOME STREET

LUMINARE SCHEDULE

SOME STREET

LUMINARE SCHEDULE

SOME STREET

SOME